


2 SITE PLAN  
Scale: 1/8" = 1'-0"



1 ROOF PLAN  
Scale: 1/8" = 1'-0"

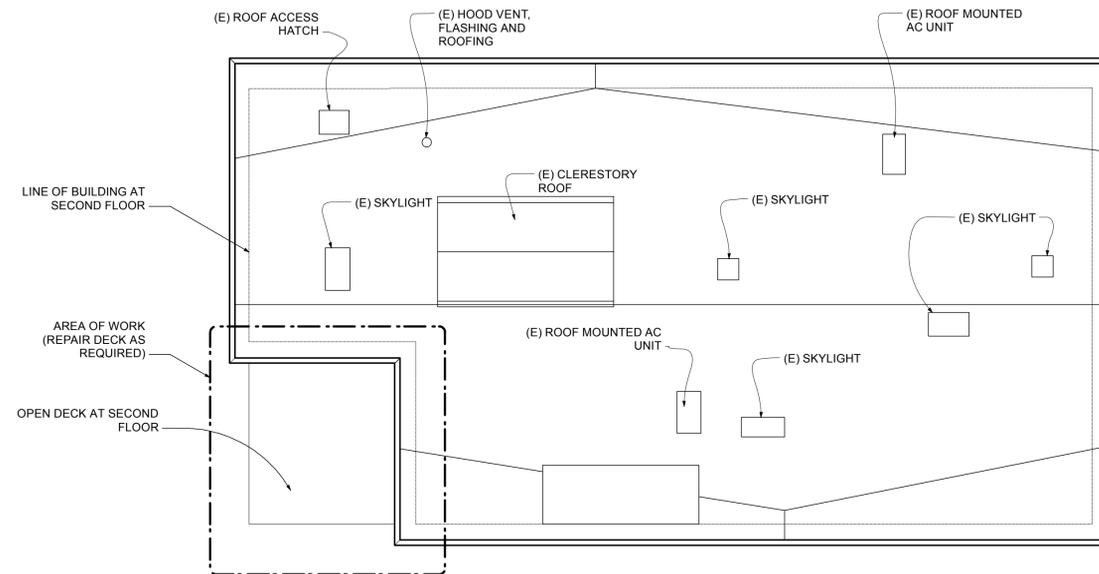

**BARTON ARCHITECT**

212 high street  
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| DATE     | DESCRIPTION      |
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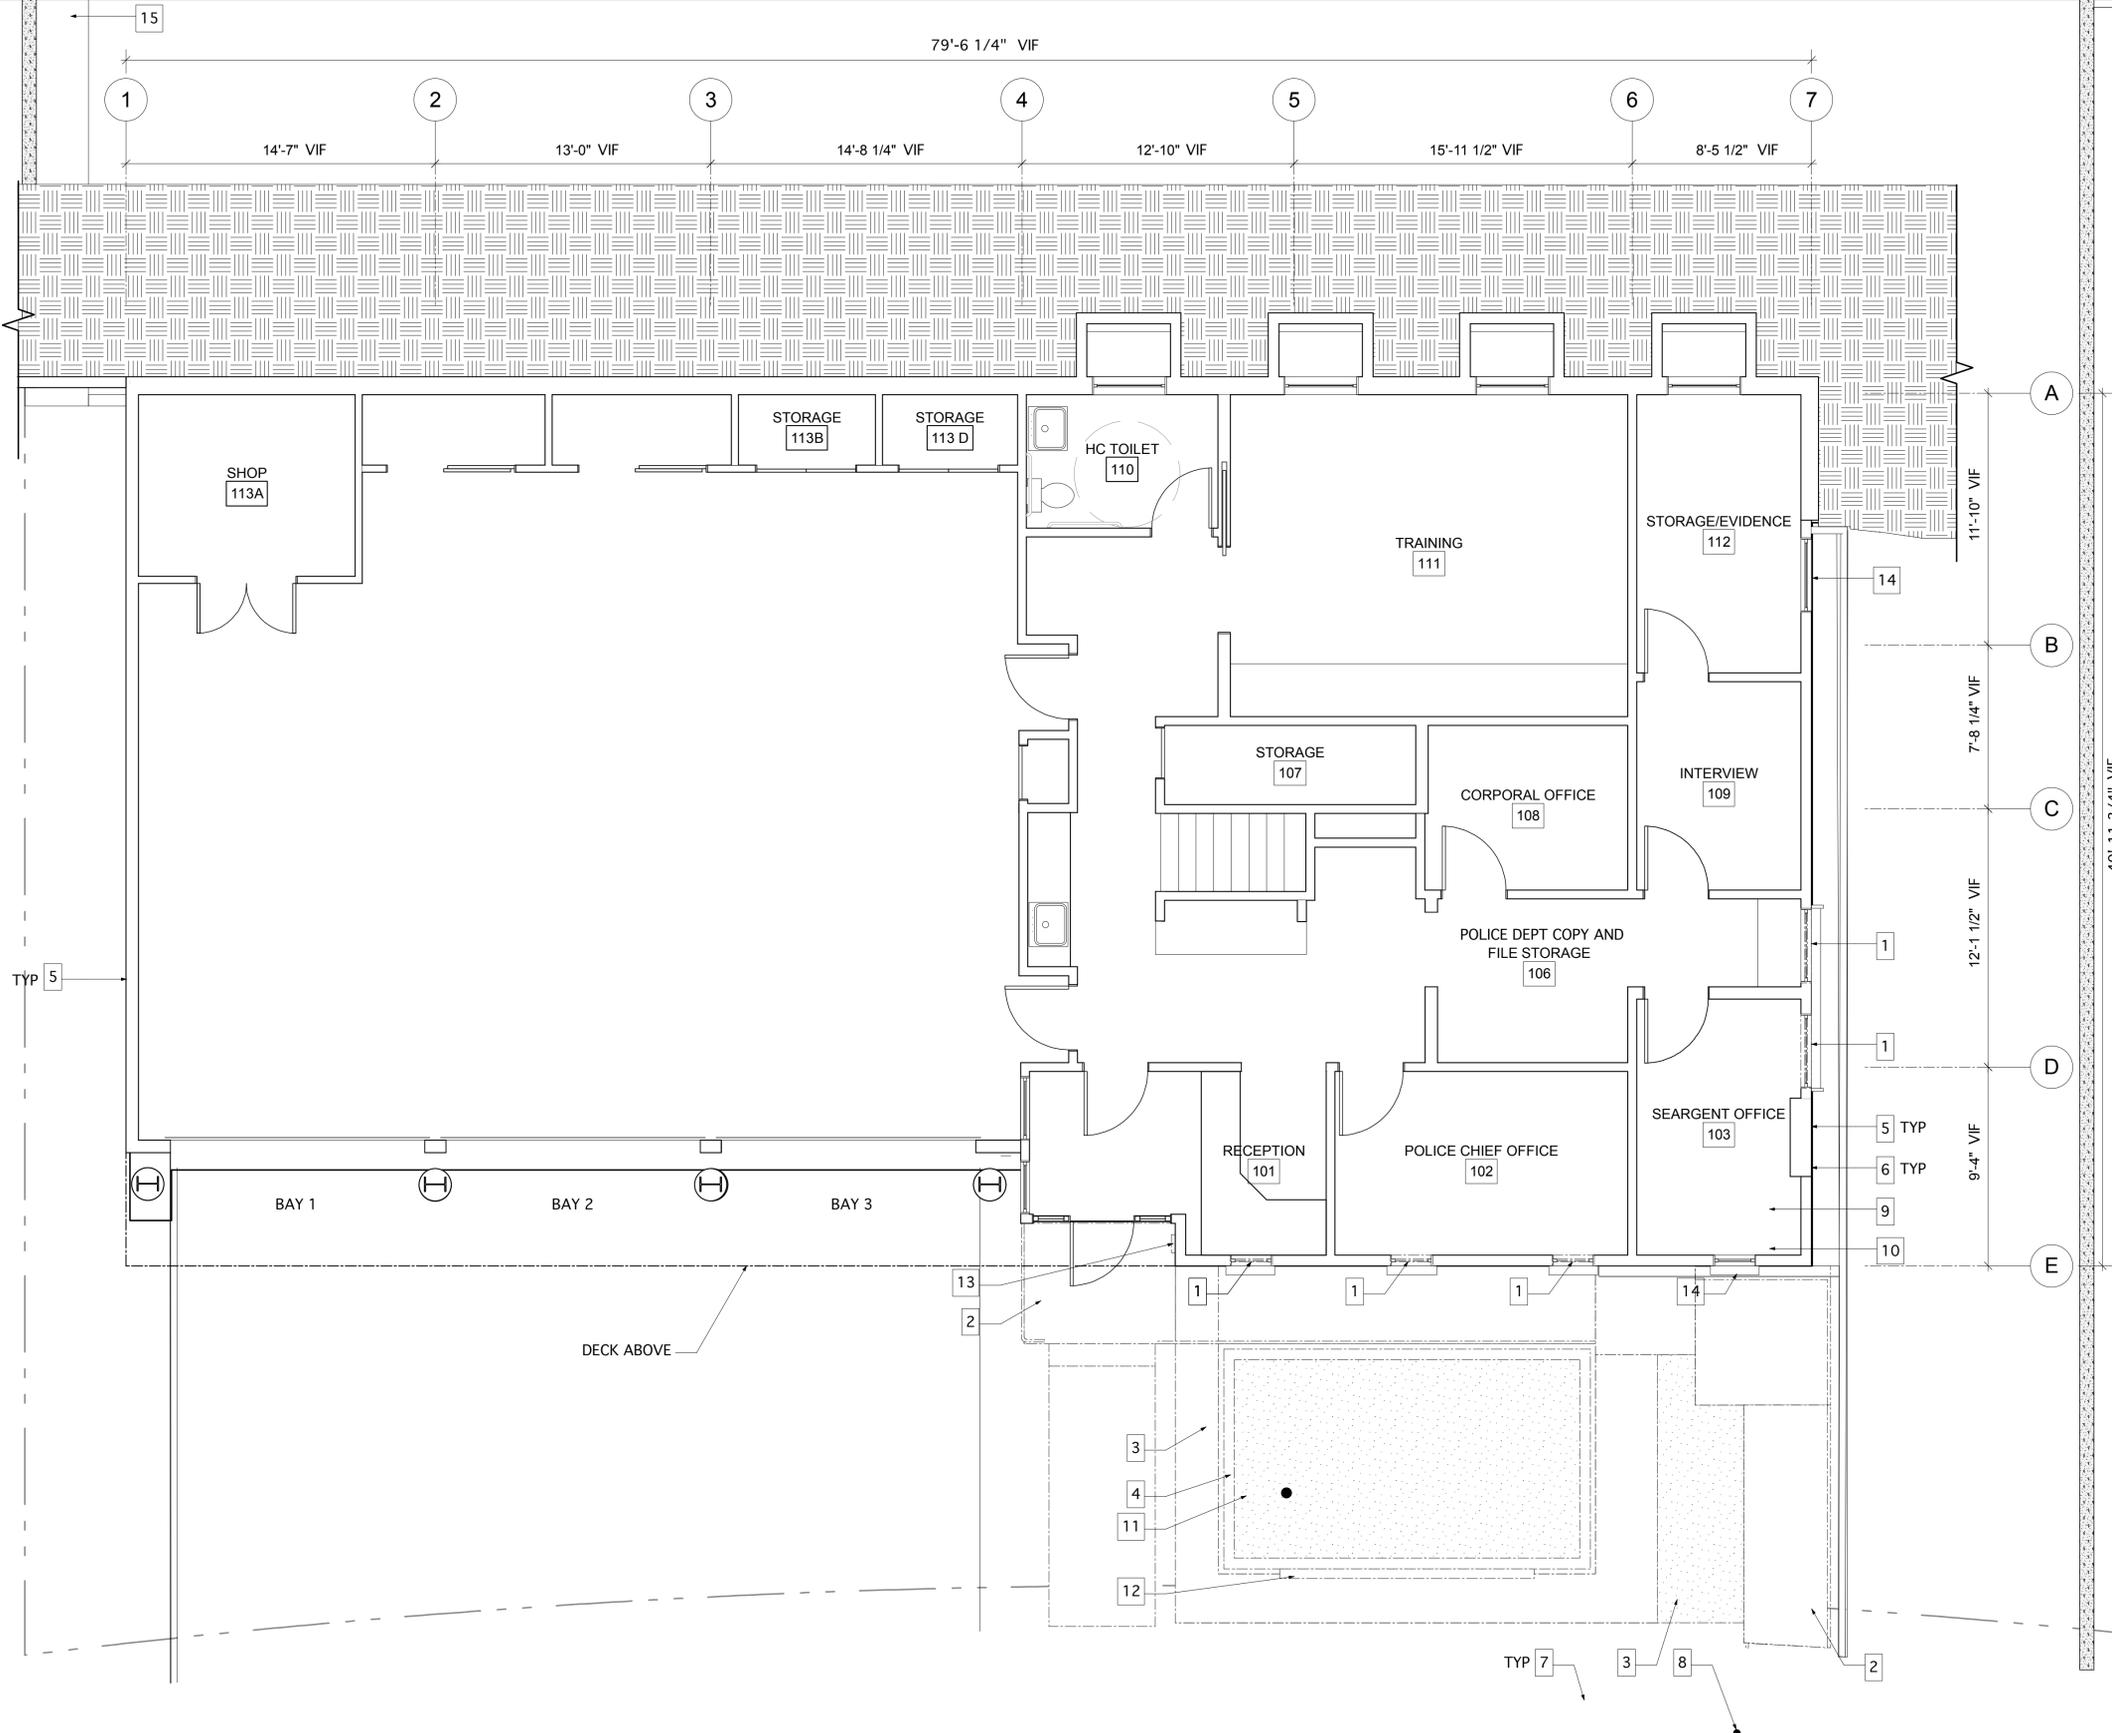
PROJECT  
**KENSINGTON FIRE STATION**

215 ARLINGTON AVE.  
KENSINGTON, CA

|             |         |
|-------------|---------|
| JOB NUMBER  | 0906    |
| DATE        | 4/30/10 |
| DRAWN BY    | AT, MJ  |
| SCALE       |         |
| DESCRIPTION |         |

**(N) SITE PLAN**

SHEET NUMBER  
**A1.0**



**GENERAL NOTES**

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- BUILDING PLANS IN THIS SET ARE DRAWN FROM OWNER'S ARCHIVED DRAWINGS. ARCHIVED DRAWINGS ARE AVAILABLE FOR REVIEW. FOR DIMENSIONS REFERENCING CONCRETE WORK (LANDING, RAMP, STAIRS), REFER TO CIVIL DRAWINGS.
2. ALL WORK SHALL BE PERFORMED IN CONFORMANCE WITH ALL LOCAL, COUNTY, STATE, AND FEDERAL CODES, LAWS, ORDINANCES, AND REGULATIONS APPLICABLE. NOTHING IN THE CONTRACT DOCUMENTS SHALL BE CONSTRUED TO PERMIT WORK NOT CONFORMING TO THESE CODES, LAWS, ORDINANCES, AND REGULATIONS.
3. CONTRACTOR SHALL ASSUME SOLE RESPONSIBILITY FOR JOBSITE CONDITIONS AND COMPLY WITH SAFETY REGULATIONS AND RESTRICTIONS AS REQUIRED FOR WORKERS' AND PEDESTRIANS' PROTECTION DURING THE COURSE OF CONSTRUCTION OF THIS PROJECT.
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5. CONTRACTOR SHALL CONTACT BOTH UNDERGROUND SERVICE ALERT (800-227-2600) AND THE AFFECTED UTILITY COMPANY PRIOR TO STARTING WORK TO REQUEST AND OBTAIN THE MARKING OF EXISTING UNDERGROUND FACILITIES.
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7. CONTRACTOR SHALL NOTIFY SOILS ENGINEER AND THE COUNTY OF CONTRA COSTA AT LEAST FORTY-EIGHT (48) HOURS PRIOR TO COMMENCEMENT OF ANY GRADING OPERATIONS ON-SITE.
8. ALL WORK WITHIN THE PUBLIC RIGHT-OF-WAY MUST BE DONE PER PUBLIC WORKS' STANDARDS BY A LICENSED CONTRACTOR WHO MUST FIRST OBTAIN A 'PERMIT FOR CONSTRUCTION IN THE PUBLIC STREET' FROM PUBLIC WORKS AT THE COUNTY.
9. OVERALL PLAN DIMENSIONS ARE GIVEN FOR FINISH FACE TO FINISH FACE AND/OR WALL CENTERLINE.
10. THROUGHOUT CONSTRUCTION AT LEAST 2 OF THE 3 BAYS AT DRIVEWAY APRON SHALL BE FUNCTIONAL AT ALL TIMES.

**FIRST FLOOR DEMOLITION PLAN NOTES**

1. REMOVE AND REPLACE WINDOW TO MATCH EXISTING. REMOVE (E) WINDOW HOOD / TRIM PER DEMO DETAIL. SEE WINDOW SCHEDULE A9.0
2. REMOVE AND REPLACE (E) CONCRETE RAMP. SCD. AT LEAST 2 OF THE 3 BAYS SHALL BE FUNCTIONAL AT ALL TIMES.
3. REMOVE (E) LANDSCAPING
4. REMOVE (E) CONCRETE PLANTER
5. REMOVE ALL (E) EXTERIOR SIDING AND (E) BUILDING PAPER ON VERTICAL SURFACES. REPORT STATES OF PLYWOOD AND EXISTENCE/EVIDENCE OF ROT OR DAMAGE TO OWNER AND ARCHITECT.
6. DETATCH ALL EXTERIOR MOUNTED WIRING, CABING, CONDUITS, AND LIGHTS. STORE LIGHTS FOR REUSE. ALL BUILDING SYSTEMS SHALL BE FUNCTIONAL THROUGHOUT CONSTRUCTION PERIOD.
7. REMOVE (E) SIDEWALK, CURBS, AND GUTTERS PER CIVIL DRAWINGS.
8. (E) STREET SIGN - RETAIN AND REMOUNT
9. PULL BACK CARPET IN THIS ROOM, AS REQUIRED
10. REMOVE AND STORE BASE MATERIAL IN THIS ROOM
11. (E) FLAGPOLE TO REMAIN
12. REMOVE AND STORE (E) LETTERING
13. (E) EXTERIOR TELEPHONE. RETAIN AND REMOUNT.
14. REMOVE (E) WINDOW HOOD/TRIM PER DEMO DETAIL. SEE WINDOW SCHEDULE A9.0
15. REMOVE (E) STORAGE SHED ROOF. SEE DETAILS 7.8,9/A7.4

**LEGEND**

- DEMOLISH (E)
- ===== CONSTRUCTION
- ===== (E) WALL

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**KENSINGTON FIRE STATION**

215 ARLINGTON AVE.  
KENSINGTON, CA


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| JOB NUMBER  | 0906    |
| DATE        | 4/30/10 |
| DRAWN BY    | AT, MJ  |
| SCALE       |         |
| DESCRIPTION |         |

**DEMO PLAN**

SHEET NUMBER  
**AD1.1**

**1 FIRST FLOOR DEMOLITION PLAN**  
Scale: 1/4" = 1'-0"



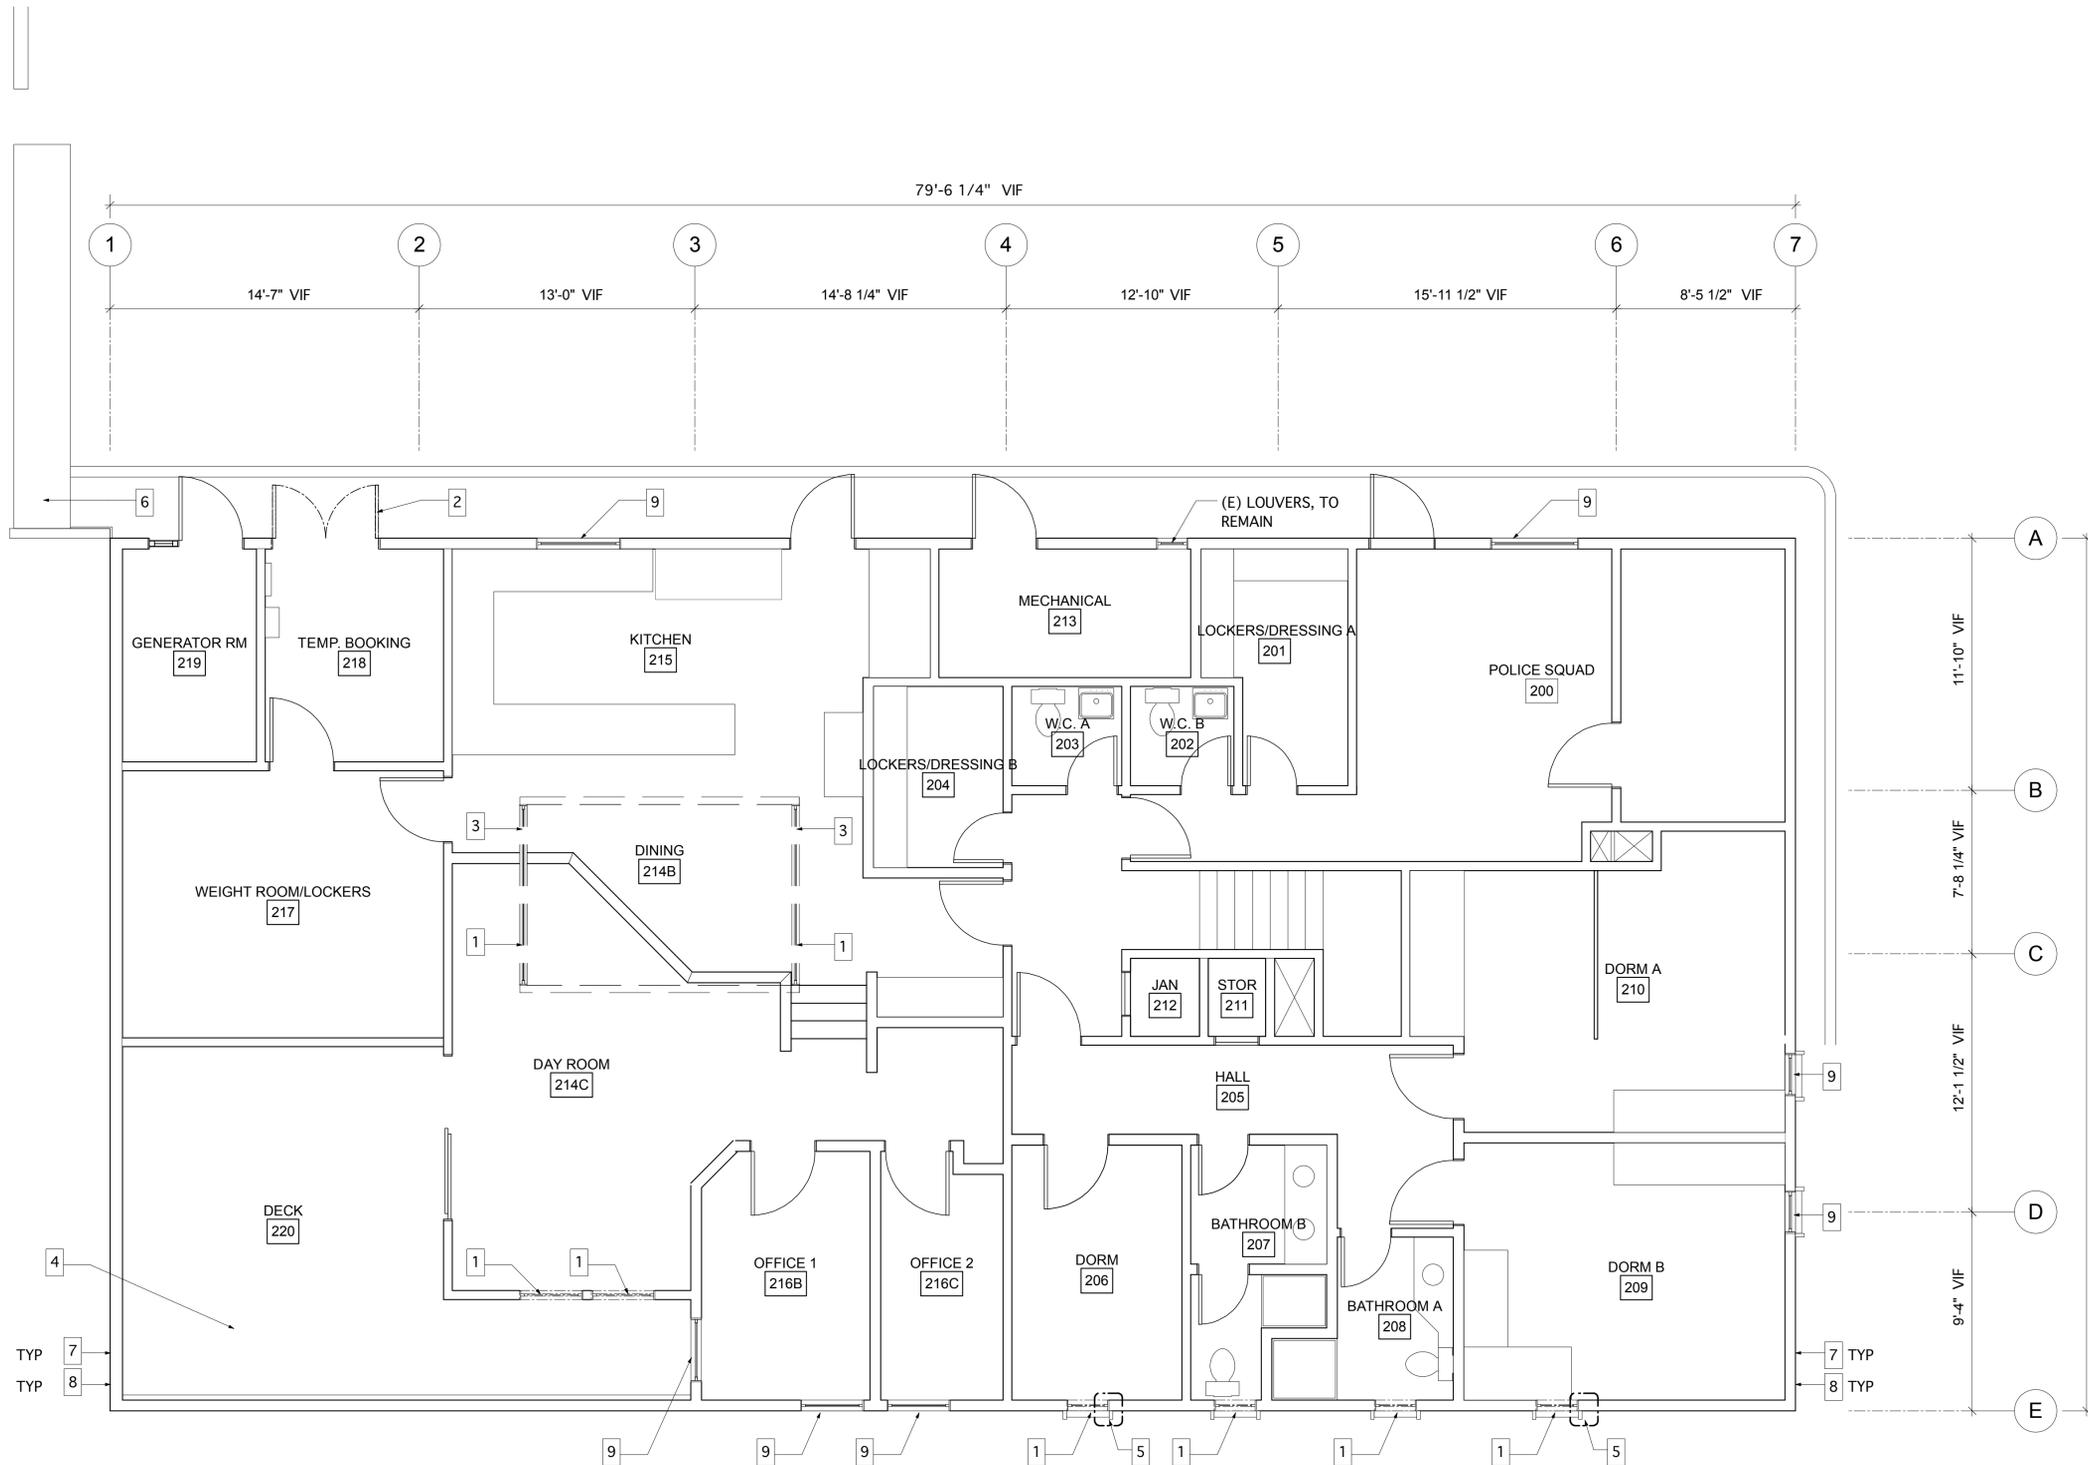

**GENERAL NOTES**

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BUILDING PLANS IN THIS SET ARE DRAWN FROM OWNER'S ARCHIVED DRAWINGS. ARCHIVED DRAWINGS ARE AVAILABLE FOR REVIEW. FOR DIMENSIONS REFERENCING CONCRETE WORK (LANDING, RAMP, STAIRS), REFER TO CIVIL DRAWINGS.

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4. ALL EXISTING UTILITY LINES ARE SHOWN FOR INFORMATION ONLY. CONTRACTOR SHALL EXERCISE ALL NECESSARY CAUTION TO AVOID DAMAGE TO ANY EXISTING UTILITY LINES OR FACILITIES TO REMAIN IN PLACE, WHETHER OR NOT SUCH FACILITIES APPEAR ON THESE PLANS. CONTRACTOR SHALL BEAR FULL RESPONSIBILITY FOR ANY DAMAGE THERE TO.

5. CONTRACTOR SHALL CONTACT BOTH UNDERGROUND SERVICE ALERT (800.327.2600) AND THE AFFECTED UTILITY COMPANY PRIOR TO STARTING WORK TO REQUEST AND OBTAIN THE MARKING OF EXISTING UNDERGROUND FACILITIES.

6. ARCHITECT SHALL BEAR NO RESPONSIBILITY FOR METHODS AND PROCEDURES OF WORK ESTABLISHED BY CONTRACTOR. JOBSITE CONDITIONS, JOBSITE SAFETY OR CONFORMANCE WITH SAFETY PROCEDURES AND REQUIREMENTS.

7. CONTRACTOR SHALL NOTIFY SOILS ENGINEER AND THE COUNTY OF CONTRA COSTA AT LEAST FORTY-EIGHT (48) HOURS PRIOR TO COMMENCEMENT OF ANY GRADING OPERATIONS ON-SITE.

8. ALL WORK WITHIN THE PUBLIC RIGHT-OF-WAY MUST BE DONE PER PUBLIC WORKS' STANDARDS BY A LICENSED CONTRACTOR WHO MUST FIRST OBTAIN A 'PERMIT FOR CONSTRUCTION IN THE PUBLIC STREET' FROM PUBLIC WORKS AT THE COUNTY.

9. OVERALL PLAN DIMENSIONS ARE GIVEN FOR FINISH FACE TO FINISH FACE AND/OR WALL CENTERLINE.

10. THROUGHOUT CONSTRUCTION, AT LEAST 2 OF THE 3 BAYS AT DRIVEWAY APRON SHALL REMAIN FUNCTIONAL AT ALL TIMES.

**FIRST FLOOR DEMOLITION PLAN NOTES**

- REMOVE (E) WINDOW AND REPLACE TO MATCH EXISTING. REMOVE (E) WINDOW HOOD/TRIM PER DEMO DETAILS. SEE WINDOW SCHEDULE A9.0
- REMOVE (E) DOORS AND REPLACE TO MATCH EXISTING
- CLERESTORY ABOVE - REMOVE AND REPLACE (E) WINDOWS AT CLERESTORY.
- REMOVE (E) FINISHES AND PLYWOOD AT DECK. INSPECT FOR DAMAGE AND REPORT TO OWNER AND ARCHITECT.
- WIDEN R.O. AS REQUIRED TO MEET CODE FOR EGRESS WINDOWS
- REMOVE (E) TOP COVER. REFER TO DETAIL 7/A7.4
- REMOVE ALL (E) EXTERIOR SIDING AND (E) BUILDING PAPER ON VERTICAL SURFACES. REPORT STATUS OF PLYWOOD AND EXISTENCE/EVIDENCE OF ROT OR DAMAGE TO OWNER AND ARCHITECT.
- DETACH ALL EXTERIOR MOUNTED WIRING, CABLING, CONDUITS, AND LIGHTS. STORE LIGHTS FOR REUSE. ALL BUILDING SYSTEMS SHALL BE FUNCTIONAL THROUGHOUT CONSTRUCTION PERIOD.
- REMOVE (E) WINDOW HOOD/TRIM PER DEMO DETAIL. SEE WINDOW SCHEDULE A9.0

**LEGEND**

- DEMOLISH (E) CONSTRUCTION
- ===== (E) WALL

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**KENSINGTON FIRE STATION**

215 ARLINGTON AVE.  
KENSINGTON, CA

JOB NUMBER 0906

DATE 4/30/10

DRAWN BY AT, MJ

SCALE

DESCRIPTION


**SECOND FLOOR DEMO PLAN**

SHEET NUMBER

AD1.2

1 SECOND FLOOR DEMOLITION PLAN  
Scale: 1/4" = 1'-0"



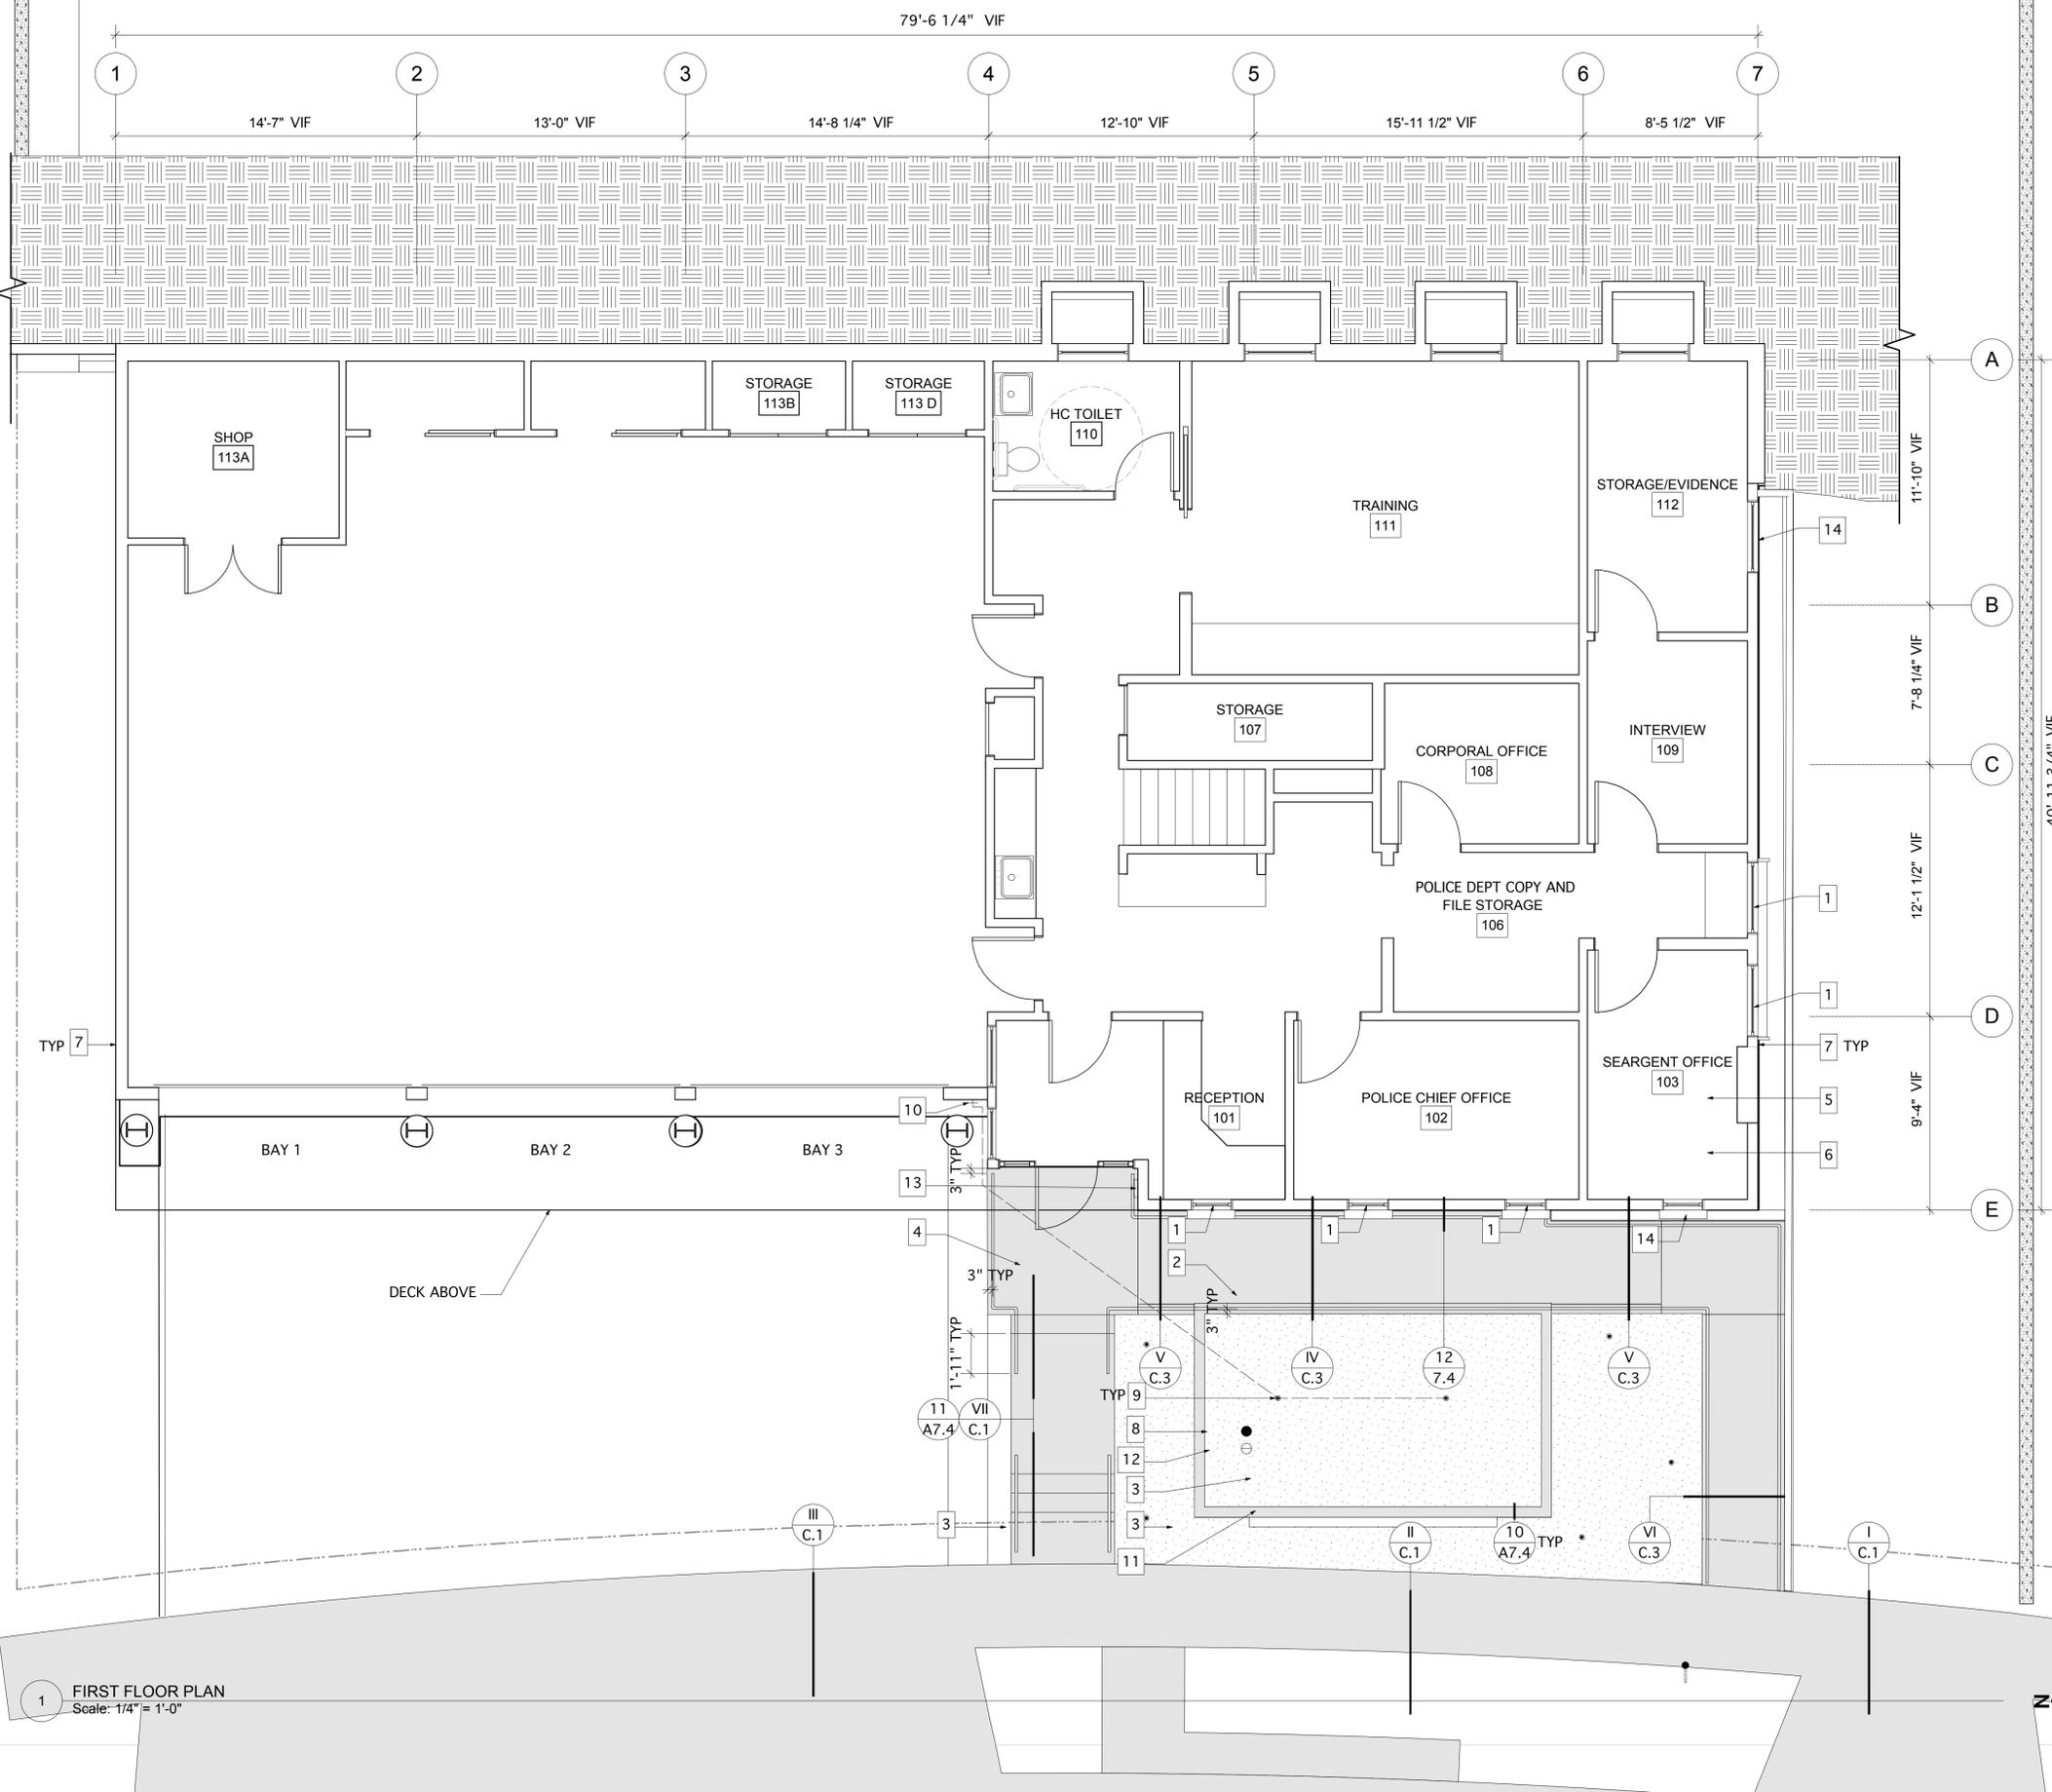

**GENERAL NOTES**

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**FLOOR PLAN NOTES**

1. (N) WINDOW TO MATCH EXISTING. (N) WINDOW TRIM. SEE WINDOW SCHEDULE A9.0
2. (N) PLANTER
3. (N) LANDSCAPING/PLANTING DESIGN BUILD, TBD
4. (N) CONCRETE RAMP AND SIDEWALK, SCD. AT LEAST 2 OF THE 3 BAYS AT DRIVEWAY APRON SHALL BE FUNCTIONAL AT ALL TIMES
5. REPLACE (E) BASE MATERIAL IN THIS ROOM
6. REPLACE (E) CARPET WHERE PULLED BACK
7. (N) SHINGLES O/ (N) BUILDING PAPER. SEE FINISH SCHEDULE, A9.0 FOR SPECIFICATIONS.
8. (E) FLAGPOLE
9. (N) 360 DEG SPRINKLER HEAD
10. (E) HOSE BIB AND (N) SPRINKLER CONTROLLER
11. REINSTALL (E) LETTERING. SEE DEMO PLAN, AD1.1
12. (N) FLAGPOLE UPLIGHT
13. (E) EXTERIOR TELEPHONE. RETAIN AND REMOUNT.
14. (N) TRIM, SEE WINDOW SCHEDULE A9.0

**WALL LEGEND**

|  |                       |
|--|-----------------------|
|  | (N) SITE CONSTRUCTION |
|  | (E) WALL              |

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**KENSINGTON FIRE STATION**


215 ARLINGTON AVE.  
 KENSINGTON, CA

|             |         |
|-------------|---------|
| JOB NUMBER  | 0906    |
| DATE        | 4/30/10 |
| DRAWN BY    | AT, MJ  |
| SCALE       |         |
| DESCRIPTION |         |

**(N) FLOOR PLAN**

SHEET NUMBER  
**A2.1**

**1 FIRST FLOOR PLAN**  
 Scale: 1/4" = 1'-0"

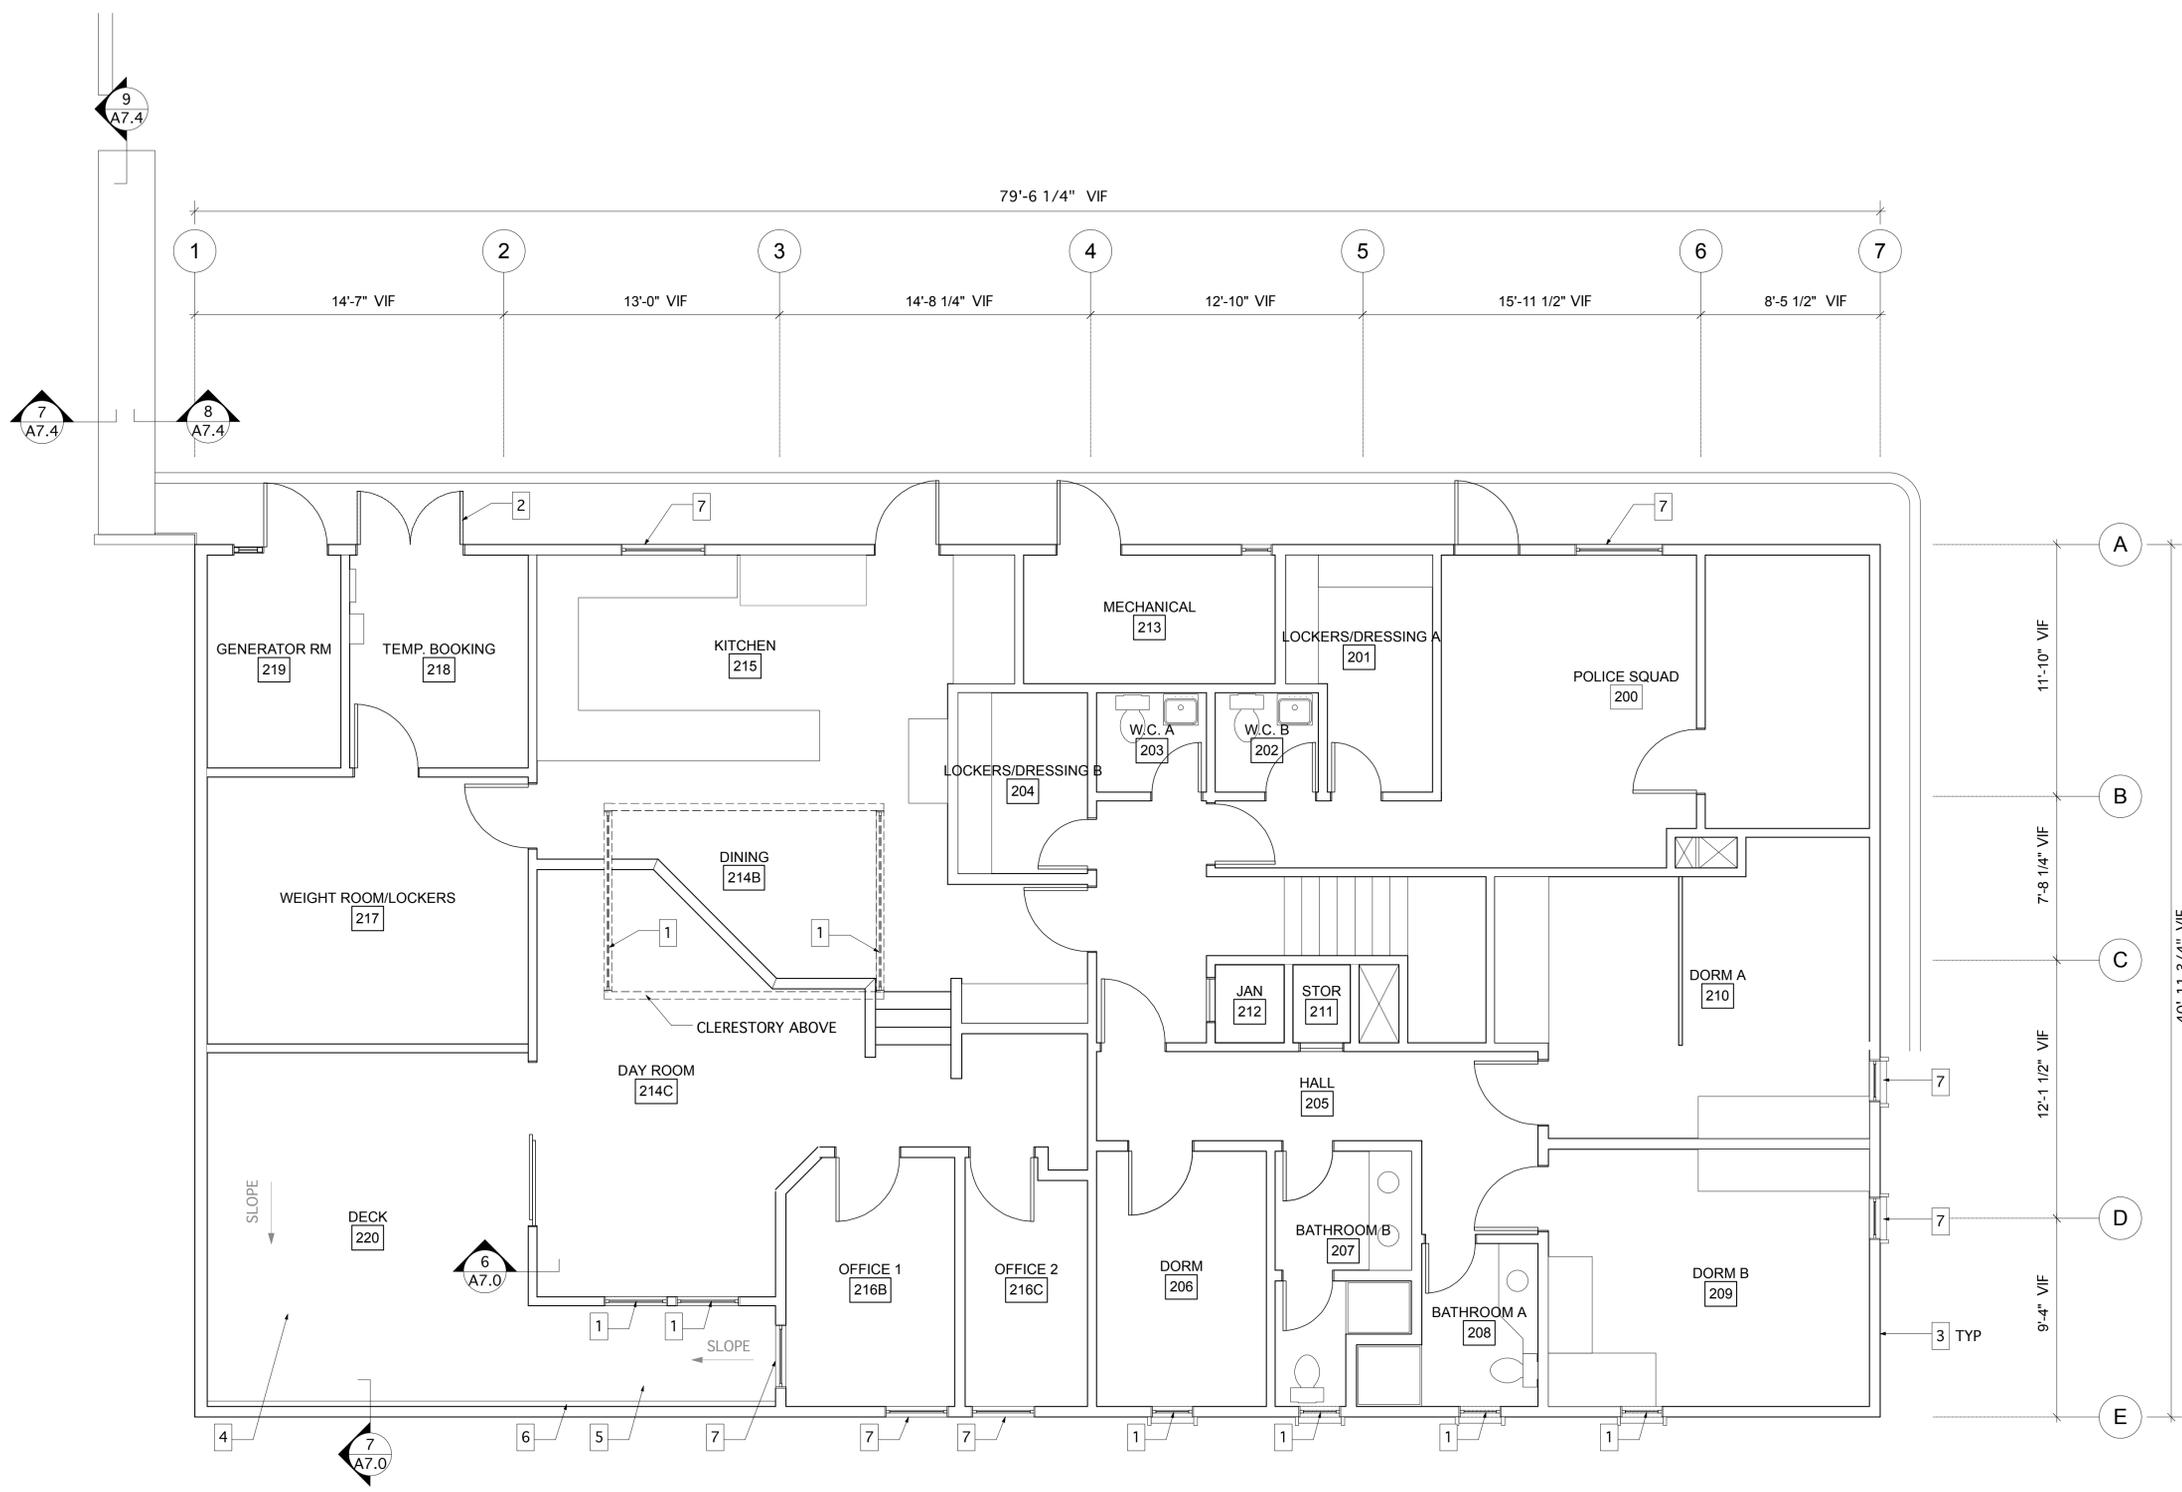

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**FLOOR PLAN NOTES**

1. (N) WINDOW TO MATCH EXISTING. (N) TRIM. SEE WINDOW SCHEDULE, A9.0
2. (N) DOORS TO MATCH EXISTING. SEE DOOR SCHEDULE, A9.0
3. (N) SHINGLES O/ (N) BUILDING PAPER. SEE FINISH SCHEDULE, A9.0 FOR SPECIFICATIONS.
4. (N) PLYWOOD AND DEXOTEX SURFACE
5. PROVIDE (N) SLOPE STRIPS AS NECESSARY TO SLOPE DECK TO DRAIN
6. (N) GUTTER
7. (N) TRIM. SEE WINDOW SCHEDULE A9.0

**WALL LEGEND**

—— (E) WALL

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PROJECT  
**KENSINGTON FIRE STATION**

215 ARLINGTON AVE.  
 KENSINGTON, CA


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| JOB NUMBER  | 0906    |
| DATE        | 4/30/10 |
| DRAWN BY    | AT, MJ  |
| SCALE       |         |
| DESCRIPTION |         |

**(N) SECOND FLOOR PLAN**

SHEET NUMBER  
**A2.2**

1 SECOND FLOOR PLAN  
 Scale: 1/4" = 1'-0"




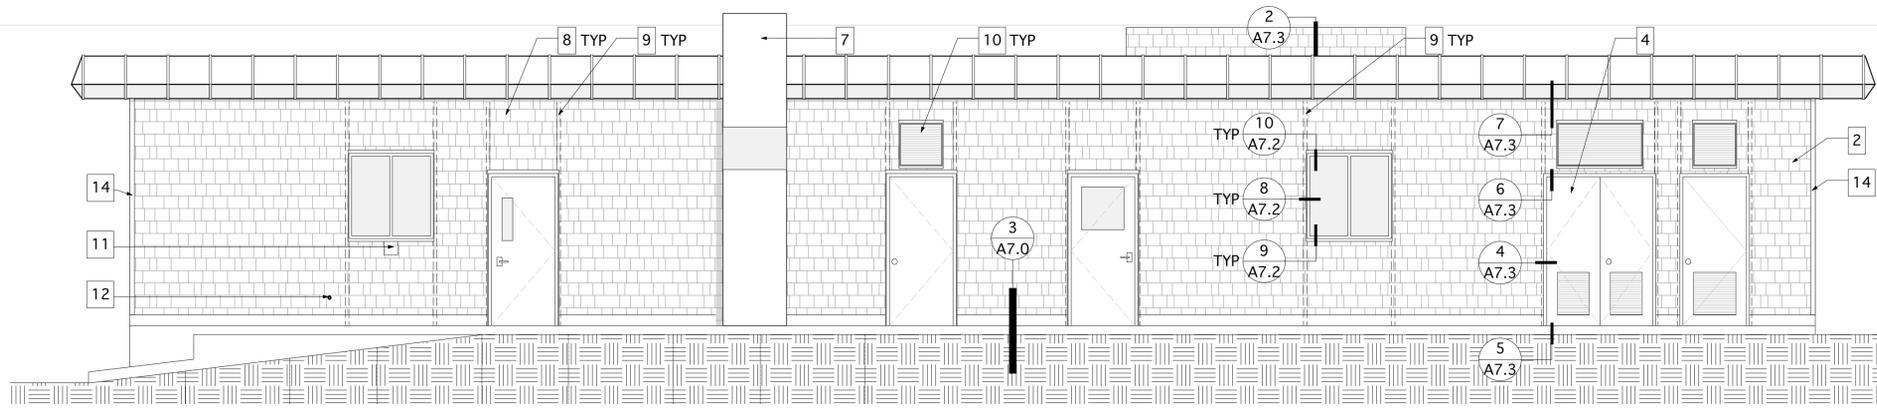


- EXTERIOR ELEVATION NOTES**
1. ALL EXISTING DOORS TO REMAIN SHALL BE REFINISHED/ REPAINTED, P-2
  2. ALL EXISTING WINDOWS TO REMAIN TO BE REFINISHED/ REPAINTED, P-2
  3. EXISTING FASCIA TO REMAIN; PROTECT IN PLACE.
  4. FOR HANDRAIL PLACEMENT AND DETAILS, REFER TO FLOOR PLAN AND CIVIL DRAWINGS.

- EXTERIOR ELEVATION KEYNOTES**
1. REMOVE AND REPLACE WINDOW TO MATCH EXISTING, SEE WINDOW SCHEDULE, A9.0
  2. REMOVE (E) SHINGLES AND REPLACE WITH EX-1. HORIZONTAL SPACING BETWEEN SHINGLES SHALL NOT EXCEED 1/4"
  3. (N) CONCRETE RAMP AND HANDRAIL, SCD.
  4. REMOVE (E) DOORS AND REPLACE TO MATCH EXISTING, SEE DOOR SCHEDULE, A9.0
  5. RETAIN AND REMOUNT (E) SIGNAGE TO MATCH (E) PLACEMENT
  6. (N) PLANTER
  7. (E) DUCT
  8. REMOVE (E) PANEL
  9. REMOVE (E) TRIM
  10. (E) LOUVER
  11. RETAIN AND REMOUNT (E) FIXTURE
  12. (E) WATER FAUCET
  13. RETAIN AND REMOUNT ALL WIRING, CABLING, LIGHTS, AND CONDUITS.
  14. (N) WOOD CORNER TRIM, P-2


4 REAR ELEVATION - EAST  
Scale: 1/4" = 1'-0"

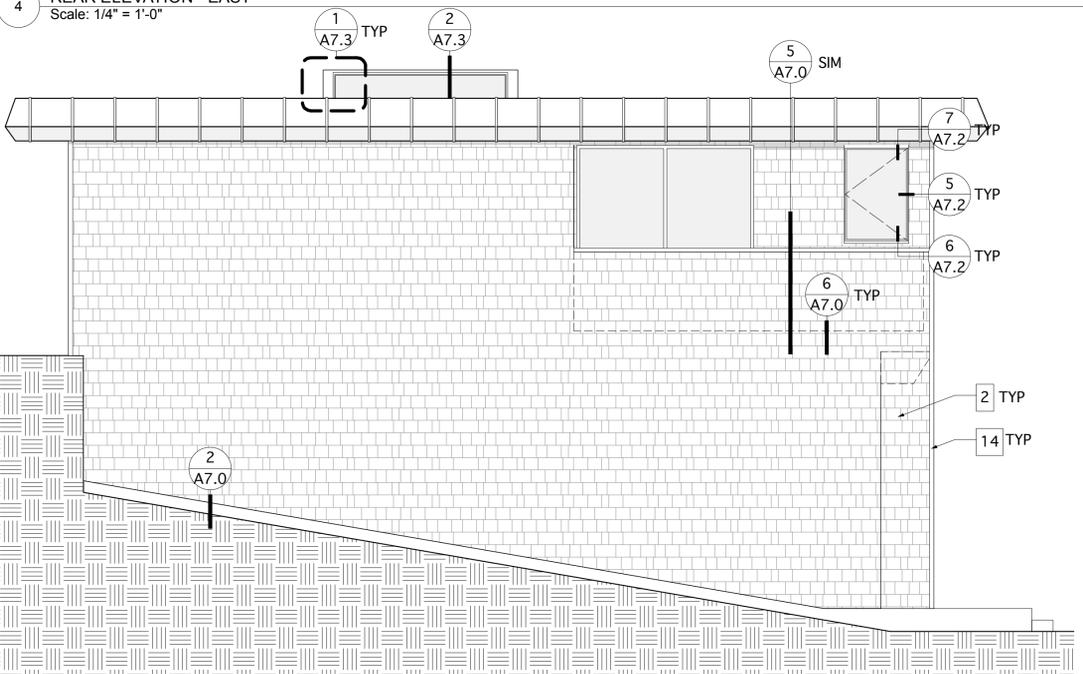

2 LEFT SIDE ELEVATION - NORTH  
Scale: 1/4" = 1'-0"

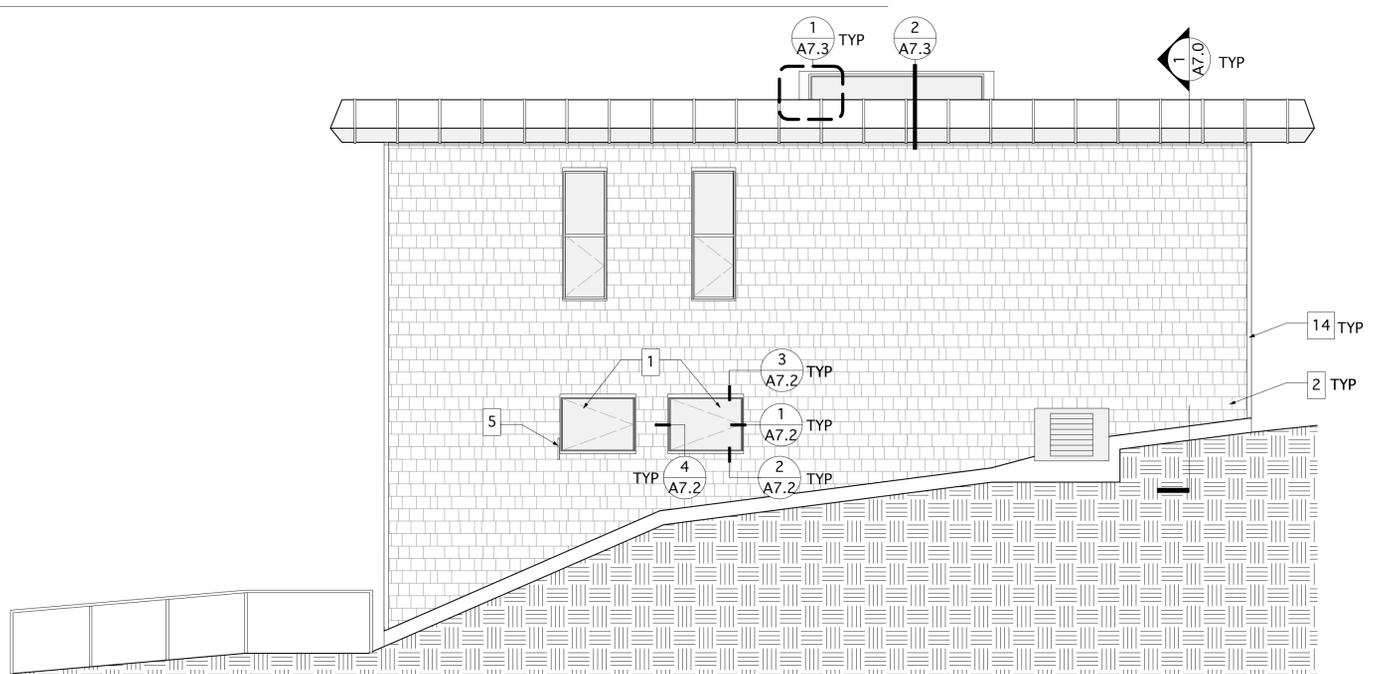

3 RIGHT SIDE ELEVATION - SOUTH  
Scale: 1/4" = 1'-0"

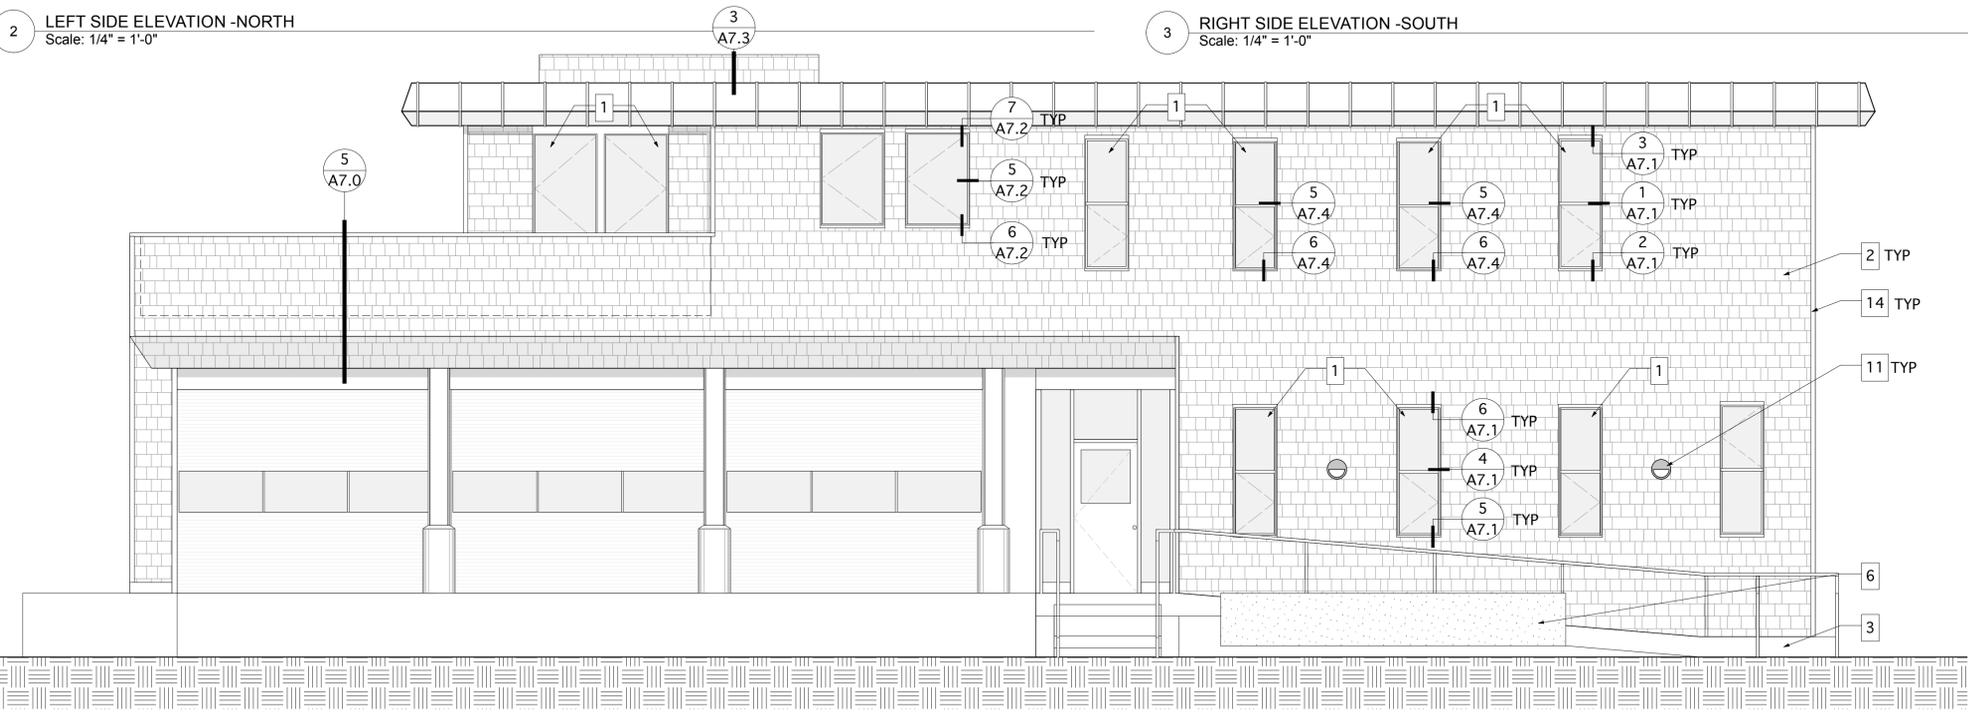

1 FRONT ELEVATION - WEST  
Scale: 1/4" = 1'-0"

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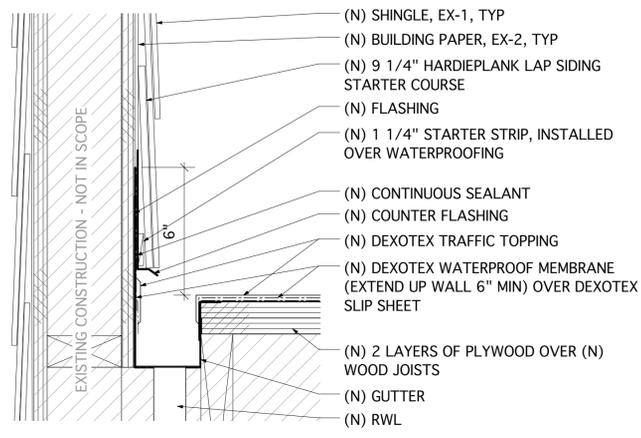
PROJECT  
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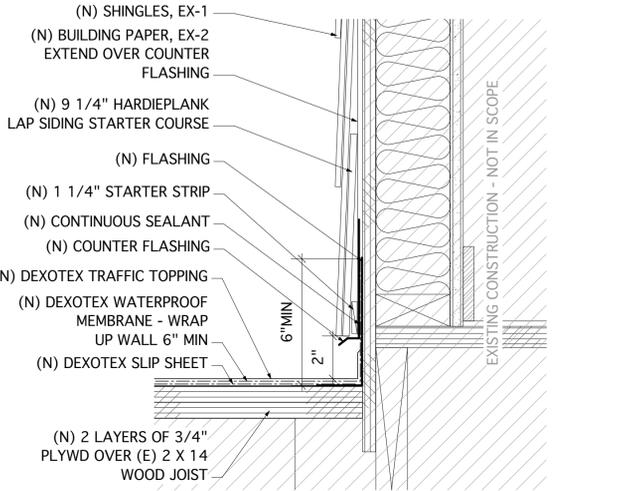
JOB NUMBER 0906  
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DRAWN BY AT, MJ  
SCALE  
DESCRIPTION

**EXTERIOR ELEVATIONS**


SHEET NUMBER  
**A3.0**




**7 DECK AT GUTTER**  
Scale: 3" = 1'-0"




**4 SECTION AT SOUTH FOUNDATION WALL**  
Scale: 3" = 1'-0"

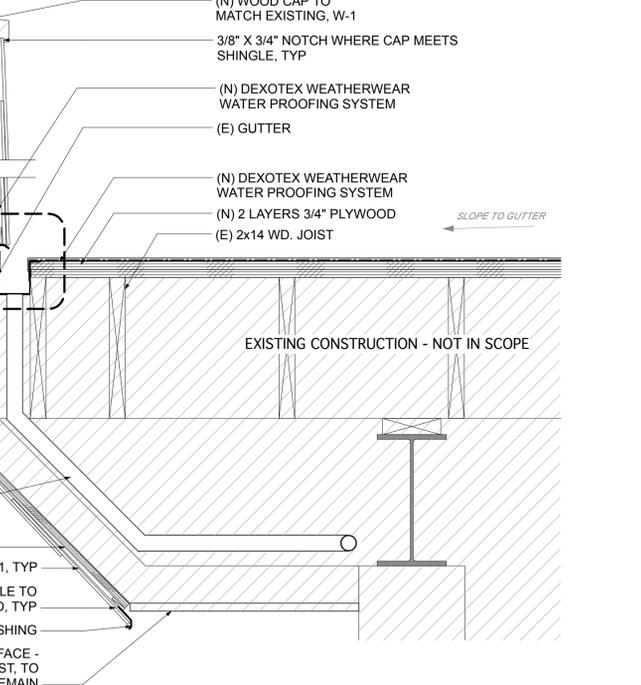


**6 EXTERIOR WALL AT DECK**  
Scale: 3" = 1'-0"

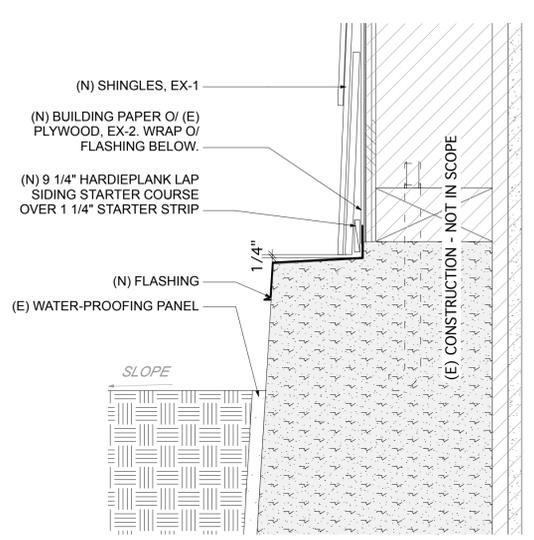

**3 SECTION AT REAR/EAST CONCRETE CURB**  
Scale: 3" = 1'-0"

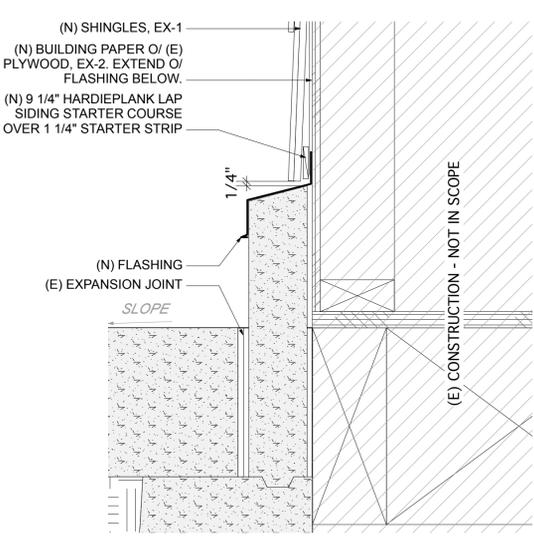

**5 SECTION THROUGH DECK WITH (E) GUTTER AND (N) RWL**  
Scale: 1 1/2" = 1'-0"

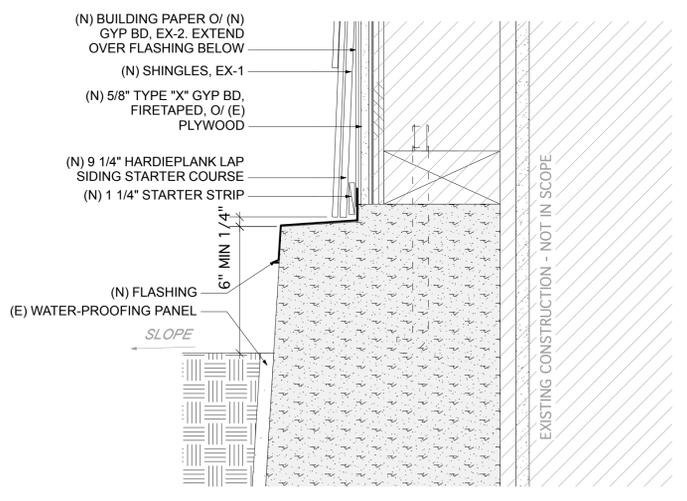


**2 SECTION AT NORTH FOUNDATION WALL**  
Scale: 3" = 1'-0"


**BUILDING DETAIL NOTES**  
1. VERIFY ALL DIMENSIONS IN FIELD. DETAILS ARE BASED FROM OWNER'S ARCHIVED DRAWINGS. ARCHIVED DRAWINGS ARE AVAILABLE FOR REVIEW AT JOBSITE.  
2. AT THE CONCLUSION OF DEMOLITION, CONSULT WITH ARCHITECT ON EXISTING CONDITIONS.  
3. FOR FINISH SPECIFICATIONS, SEE MATERIALS AND FINISHES SCHEDULE, A9.0  
4. FOR ALL FLASHING DIMENSIONS, USE SMACNA STANDARDS.  
5. ALL (N) SHINGLES TO BE FASTENED TO (E) STUDS.



**1 SECTION AT WEST FOUNDATION WALL**  
Scale: 3" = 1'-0"

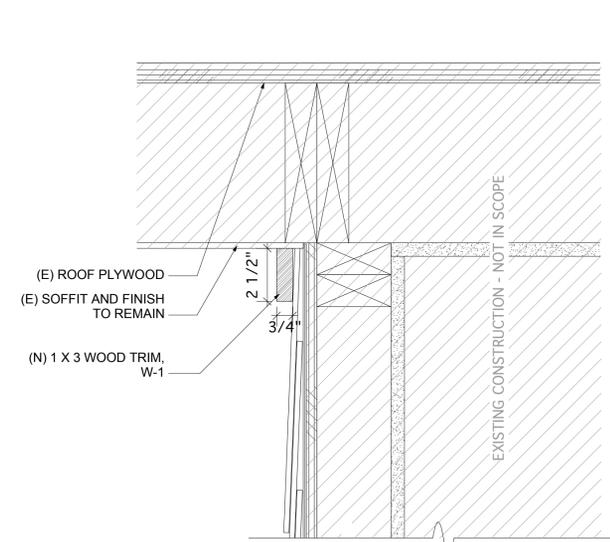

**7 SECTION AT WEST FOUNDATION WALL**  
Scale: 3" = 1'-0"

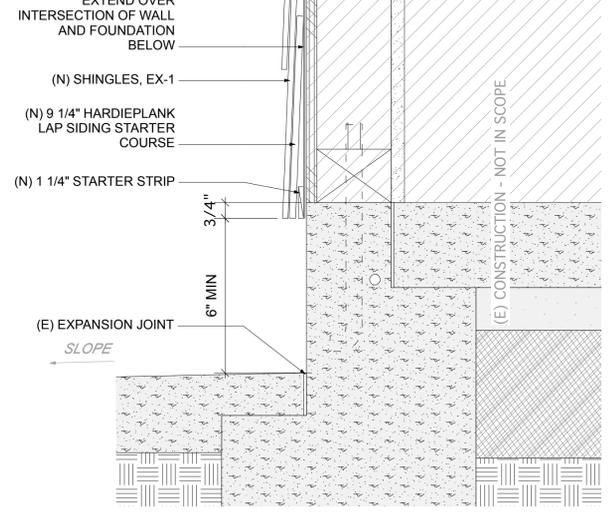

**1 SECTION AT WEST FOUNDATION WALL**  
Scale: 3" = 1'-0"

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jbaron@bartonarchitect.com

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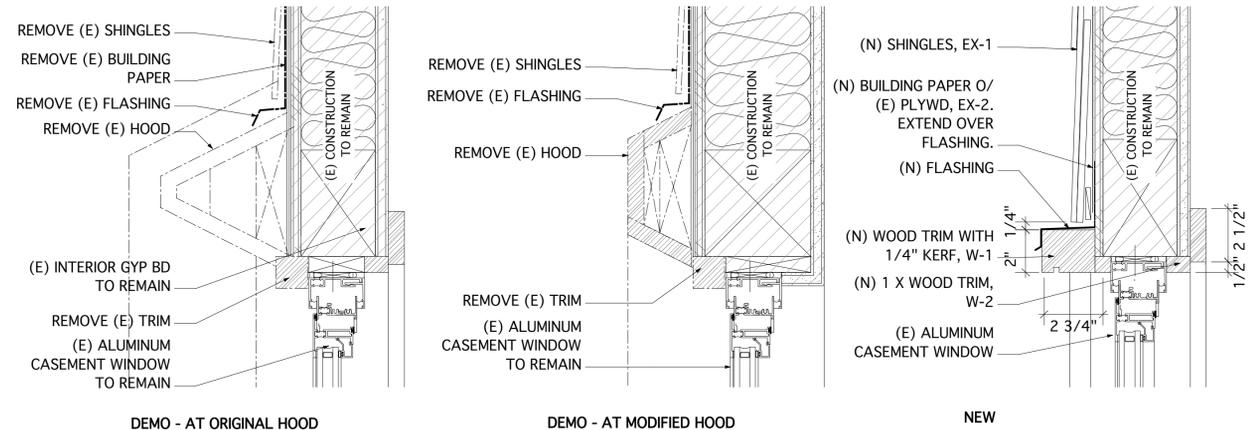
PROJECT  
**KENSINGTON FIRE STATION**

215 ARLINGTON AVE.  
KENSINGTON, CA


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|-------------|---------|
| JOB NUMBER  | 0906    |
| DATE        | 4/30/10 |
| DRAWN BY    | AT, MJ  |
| SCALE       |         |
| DESCRIPTION |         |

**BUILDING DETAILS**


SHEET NUMBER  
**A7.0**




6 NEW TRIM AT EXISTING ALUMINUM WINDOW / TYPE A - HEAD  
Scale: 3" = 1'-0"

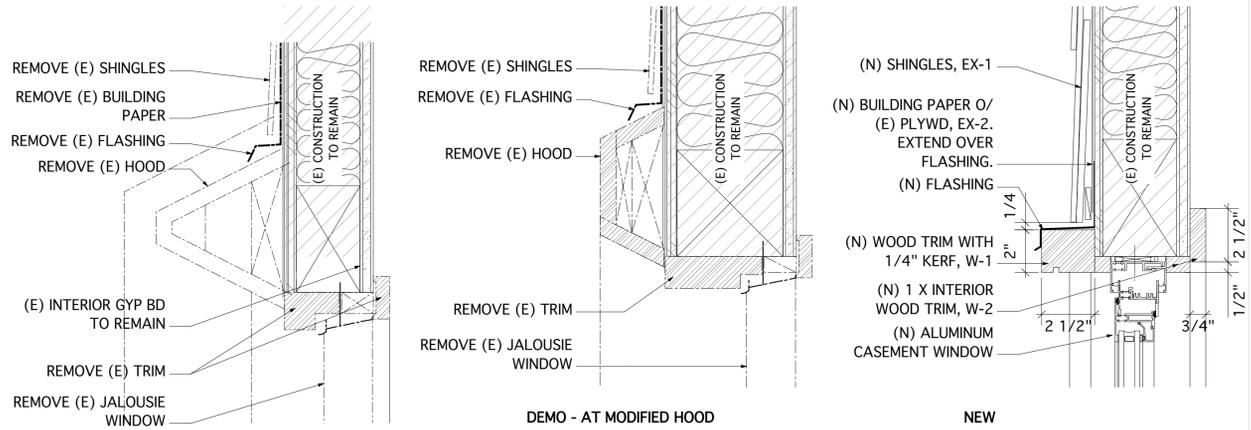


3 NEW ALUMINUM WINDOW AT EXISTING JALOUSIE / TYPE A - HEAD  
Scale: 3" = 1'-0"

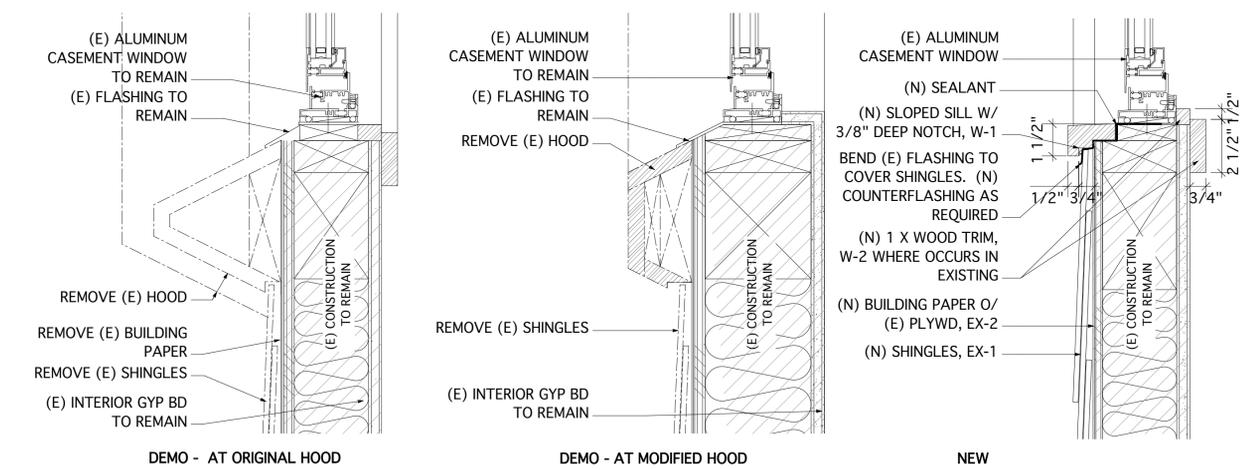


5 NEW TRIM AT EXISTING ALUMINUM WINDOW / TYPE A - SILL  
Scale: 3" = 1'-0"

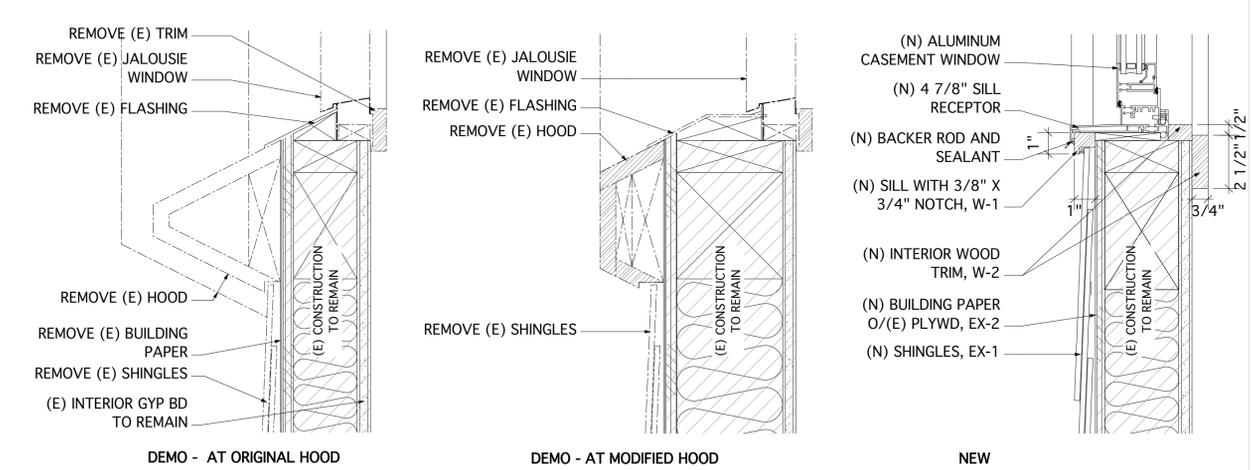

2 NEW ALUMINUM WINDOW AT EXISTING JALOUSIE / TYPE A - SILL  
Scale: 3" = 1'-0"

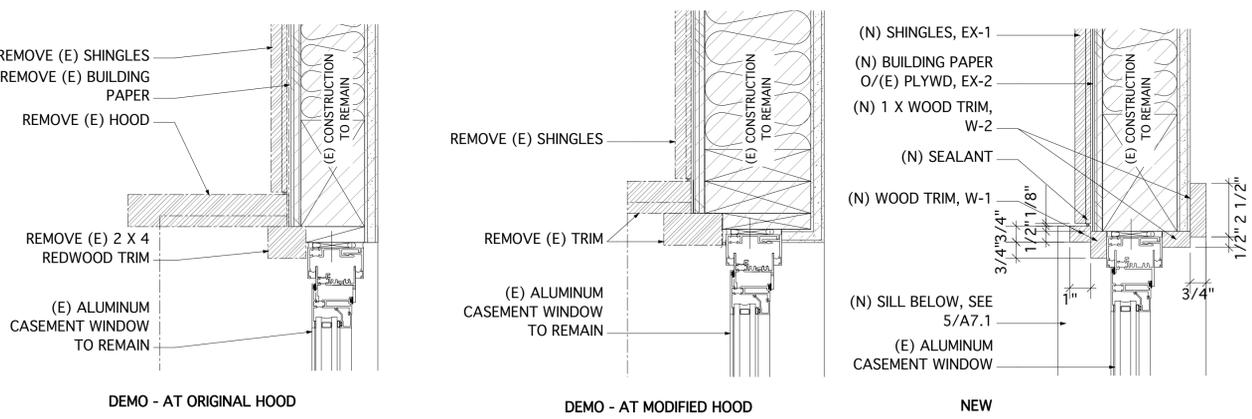

4 NEW TRIM AT EXISTING ALUMINUM WINDOW / TYPE A - JAMB  
Scale: 3" = 1'-0"

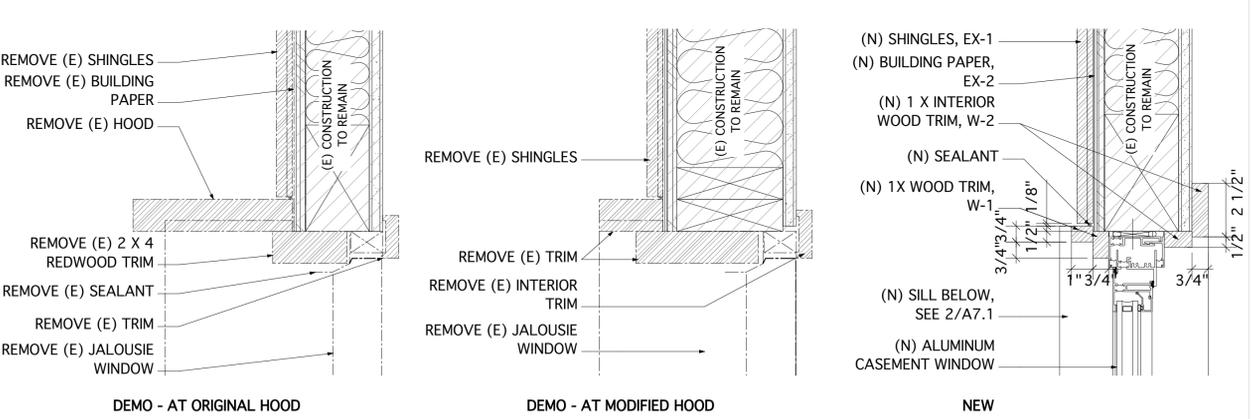

1 NEW ALUMINUM WINDOW AT EXISTING JALOUSIE / TYPE A - JAMB  
Scale: 3" = 1'-0"

**WINDOW DETAIL NOTES**  
 1. VERIFY ALL DIMENSIONS IN FIELD. DETAILS ARE BASED FROM OWNER'S ARCHIVED DRAWINGS.  
 2. ARCHIVED DRAWINGS ARE AVAILABLE FOR REVIEW AT JOBSITE.  
 3. AT THE CONCLUSION OF DEMOLITION, CONSULT WITH ARCHITECT ON EXISTING CONDITIONS.  
 4. FOR FINISH SPECIFICATIONS, SEE MATERIALS AND FINISHES SCHEDULE, A9.0  
 5. FOR WINDOW SPECIFICATIONS, SEE WINDOW SCHEDULE, A9.0  
 6. ALL (E) INTERIOR FINISHES TO REMAIN UNLESS OTHERWISE NOTED  
 7. TOUCH UP INTERIOR PAINT AT GYP BD ADJACENT TO WINDOWS  
 8. FOR ALL FLASHING DIMENSIONS, USE SMACNA STANDARDS.  
 9. INSTALL AN UNDERLAYMENT, EX-4, 24" AROUND ALL WINDOW PENETRATIONS PRIOR TO INSTALLMENT OF (N) WINDOW SYSTEMS.

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**KENSINGTON FIRE STATION**

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 KENSINGTON, CA

|             |                         |
|-------------|-------------------------|
| PROJECT     | KENSINGTON FIRE STATION |
| JOB NUMBER  | 0906                    |
| DATE        | 4/30/10                 |
| DRAWN BY    | AT, MJ                  |
| SCALE       |                         |
| DESCRIPTION | WINDOW DETAILS          |

**WINDOW DETAILS**

SHEET NUMBER  
**A7.1**


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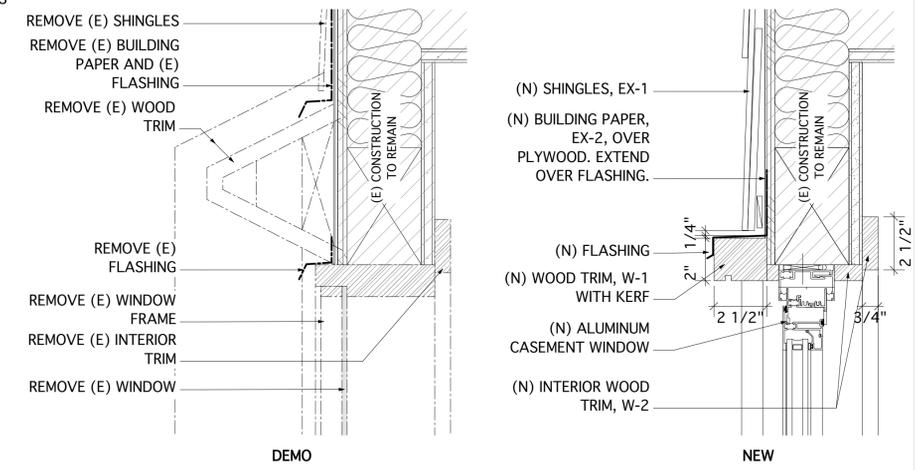
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| 04.30.10 | BID / PERMIT SET |
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**WINDOW DETAIL NOTES**


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4. FOR WINDOW SPECIFICATIONS, SEE WINDOW SCHEDULE, A9.0
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6. TOUCH UP INTERIOR PAINT AT GYP BD ADJACENT TO WINDOWS
7. FOR ALL FLASHING DIMENSIONS, USE SMACNA STANDARDS.
8. INSTALL AN UNDERLAYMENT, EX-4, 24" AROUND ALL WINDOW PENETRATIONS PRIOR TO INSTALLMENT OF (N) WINDOW SYSTEMS.




7 EXISTING ALUMINUM WINDOW / TYPE D - HEAD  
Scale: 3" = 1'-0"

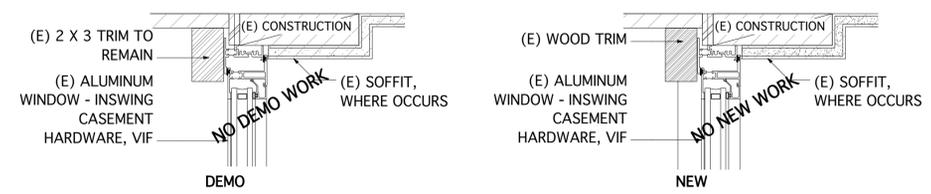


3 NEW ALUMINUM WINDOW AT EXISTING FIXED GLASS / TYPE B - HEAD  
Scale: 3" = 1'-0"

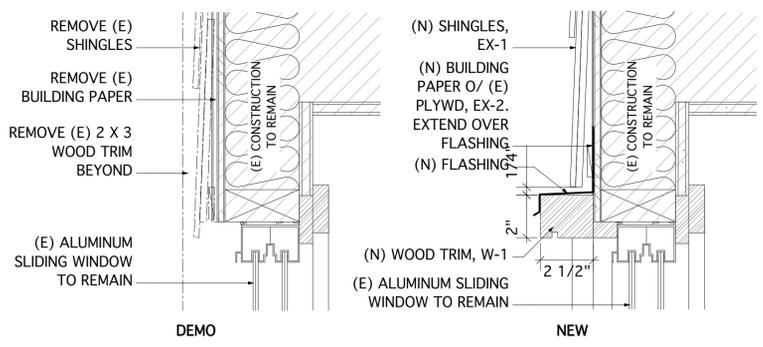


10 NEW TRIM AT EXISTING SLIDING ALUMINUM WINDOW / TYPE E - HEAD  
Scale: 3" = 1'-0"

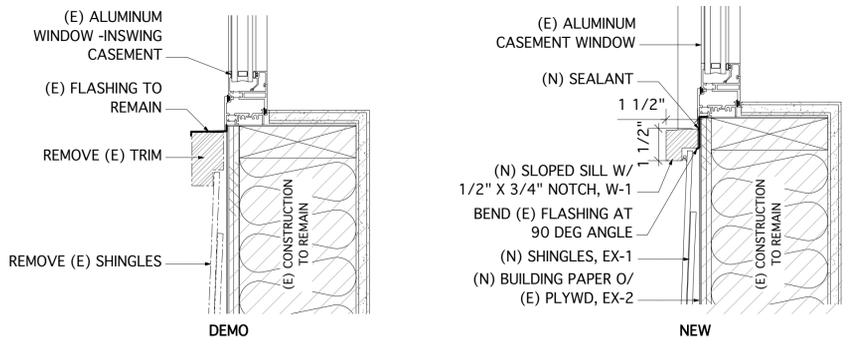


6 NEW TRIM AT EXISTING ALUMINUM WINDOW / TYPE D - SILL  
Scale: 3" = 1'-0"

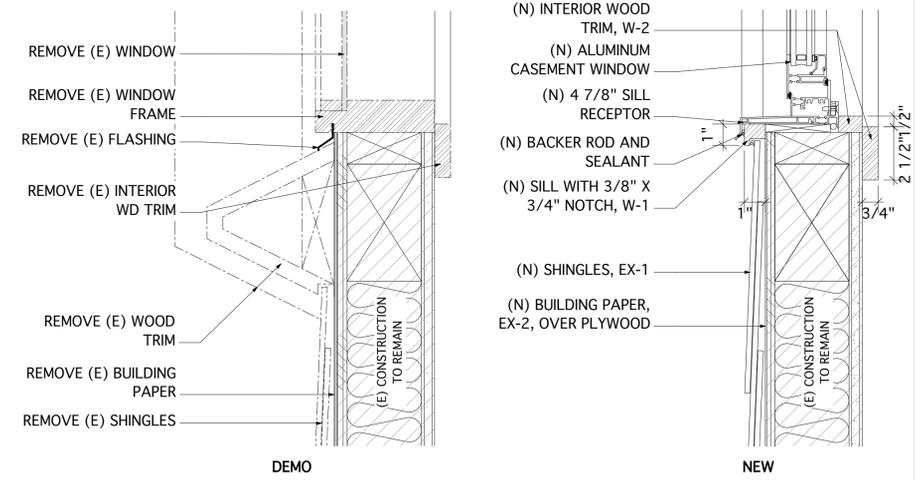


2 NEW ALUMINUM WINDOW AT EXISTING FIXED GLASS / TYPE B - SILL  
Scale: 3" = 1'-0"

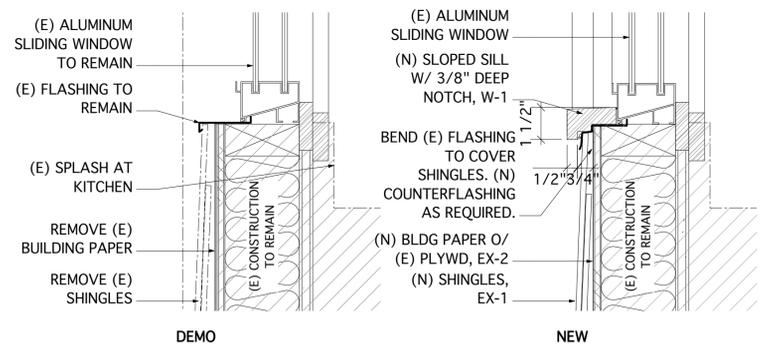


9 NEW TRIM AT EXISTING ALUMINUM SLIDING WINDOW / TYPE E - SILL  
Scale: 3" = 1'-0"

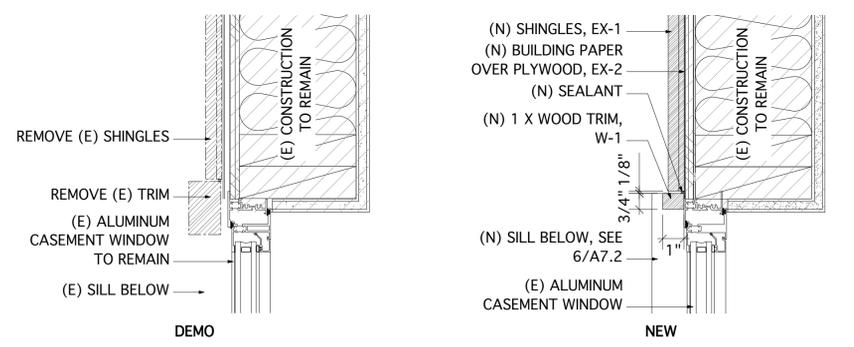


5 NEW TRIM AT EXISTING ALUMINUM WINDOW / TYPE D - JAMB  
Scale: 3" = 1'-0"

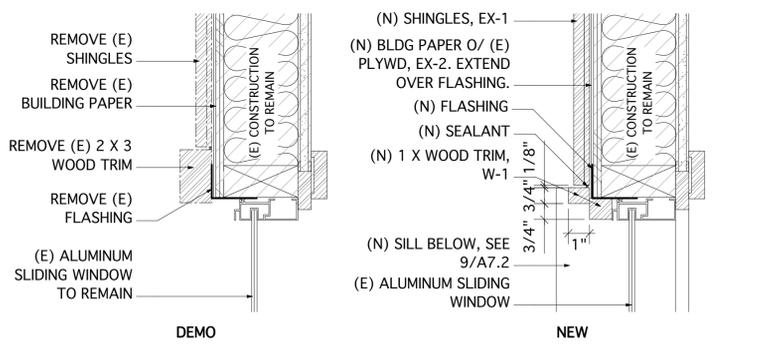

8 NEW TRIM AT EXISTING ALUMINUM SLIDING WINDOW / TYPE E - JAMB  
Scale: 3" = 1'-0"

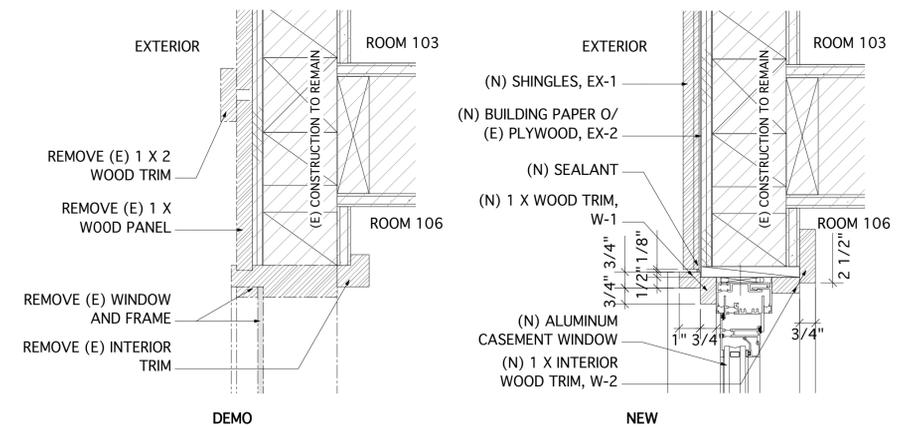

4 NEW ALUMINUM WINDOW AT EXISTING FIXED GLASS / TYPE B - MULLION  
Scale: 3" = 1'-0"

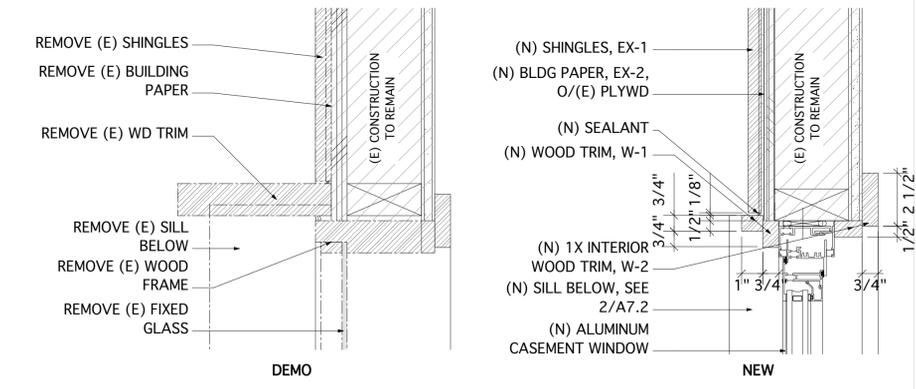

1 NEW ALUMINUM WINDOW AT EXISTING FIXED GLASS / TYPE B - JAMB  
Scale: 3" = 1'-0"


**KENSINGTON FIRE STATION**

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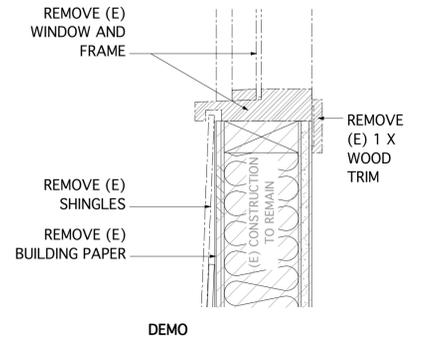
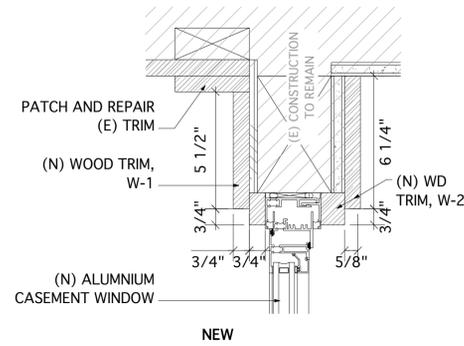
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|-------------|---------|
| JOB NUMBER  | 0906    |
| DATE        | 4/30/10 |
| DRAWN BY    | AT, MJ  |
| SCALE       |         |
| DESCRIPTION |         |

**WINDOW DETAILS**


SHEET NUMBER  
**A7.2**

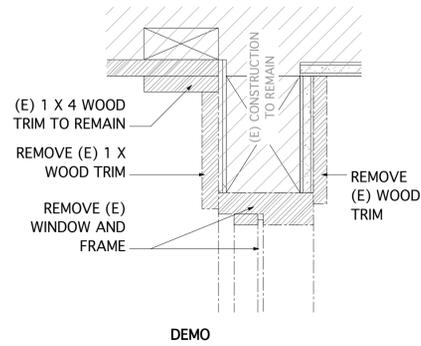



11 EXISTING FIXED GLASS WINDOW / TYPE F - HEAD  
Scale: 3" = 1'-0"




10 EXISTING FIXED GLASS WINDOW / TYPE F - SILL  
Scale: 3" = 1'-0"

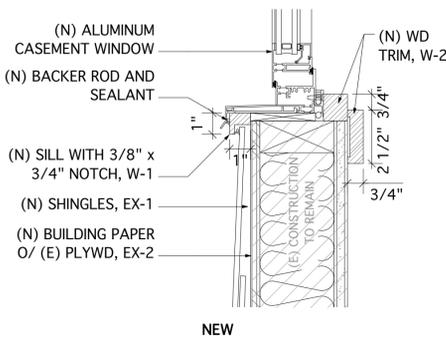


9 EXISTING FIXED GLASS WINDOW / TYPE F - JAMB  
Scale: 3" = 1'-0"

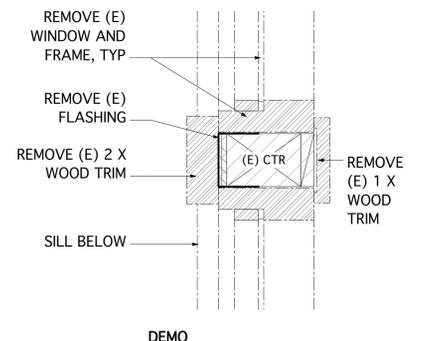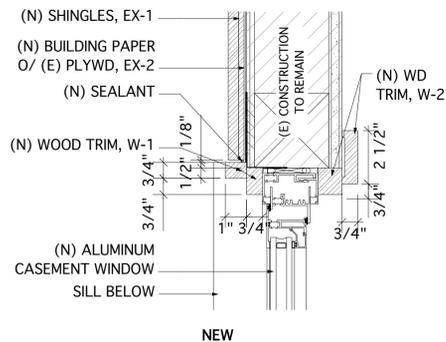


8 EXISTING FIXED GLASS WINDOW / TYPE F - MULLION  
Scale: 3" = 1'-0"

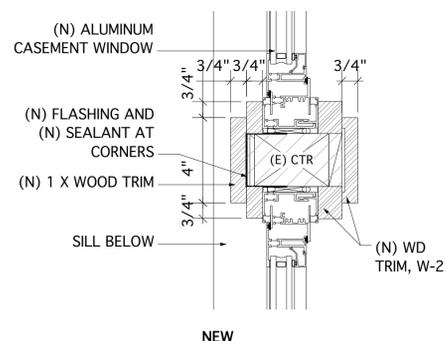


5 THRESHOLD AT REAR DOORS  
Scale: 3" = 1'-0"

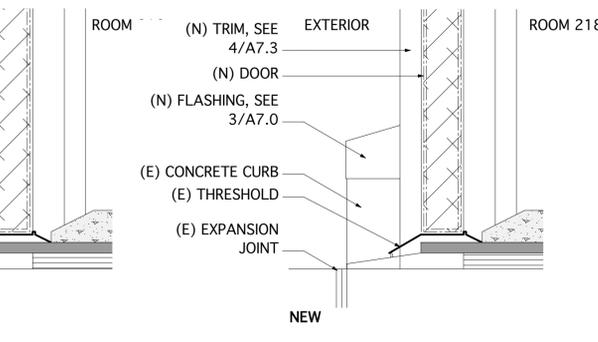


4 JAMB AT REAR DOORS  
Scale: 3" = 1'-0"

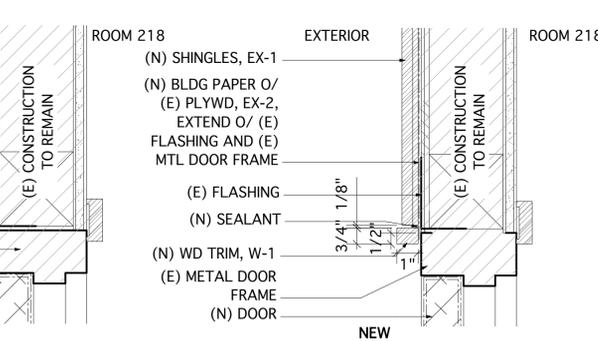


7 HEAD AT REAR DOORS  
Scale: 3" = 1'-0"

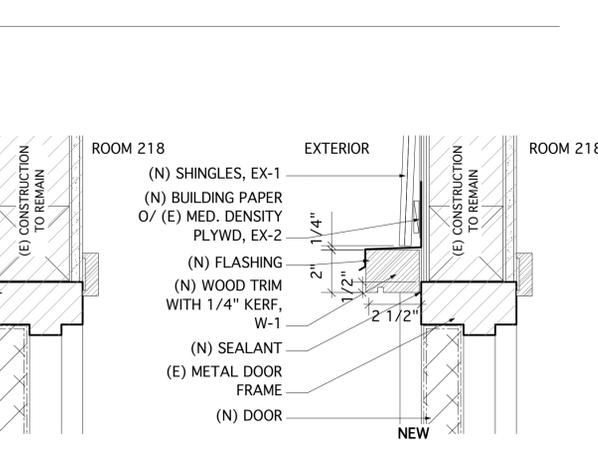

3 SECTION THROUGH CLERESTORY AT WALL  
Scale: 1 1/2" = 1'-0"

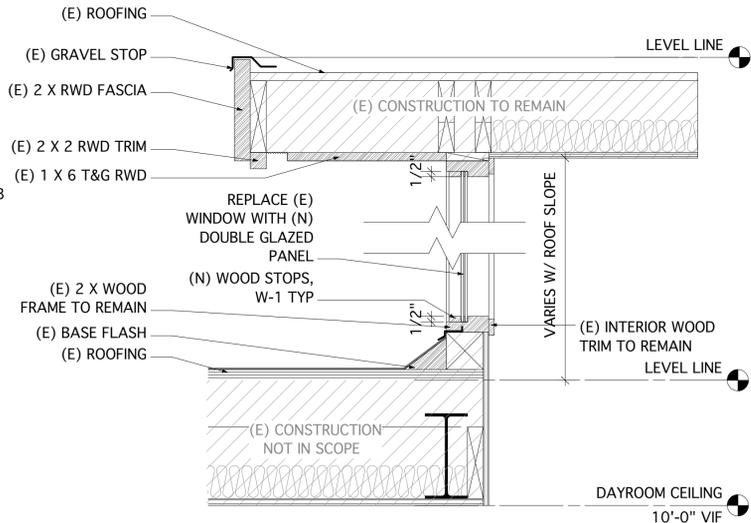


2 SECTION THROUGH CLERESTORY AT GLASS  
Scale: 1 1/2" = 1'-0"

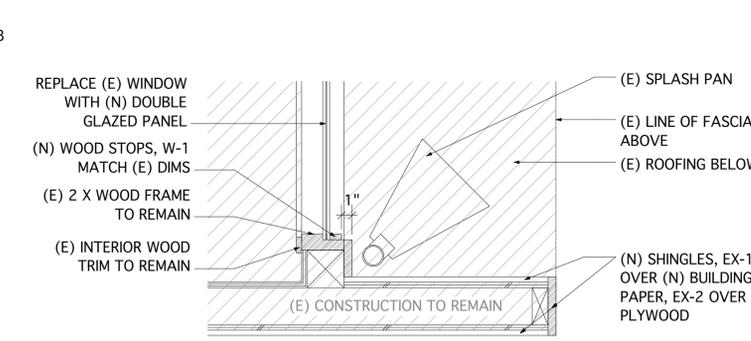


1 PLAN AT CLERESTORY CORNER / JAMB  
Scale: 1 1/2" = 1'-0"


**DOOR AND WINDOW DETAIL NOTES**  
1. VERIFY ALL DIMENSIONS IN FIELD. DETAILS ARE BASED FROM OWNER'S ARCHIVED DRAWINGS. ARCHIVED DRAWINGS ARE AVAILABLE FOR REVIEW AT JOBSITE.  
2. AT THE CONCLUSION OF DEMOLITION, CONSULT WITH ARCHITECT ON EXISTING CONDITIONS.  
3. FOR FINISH SPECIFICATIONS, SEE MATERIALS AND FINISHES SCHEDULE, A9.0  
4. FOR WINDOW SPECIFICATIONS, SEE WINDOW SCHEDULE, A9.0  
5. FOR DOOR SPECIFICATIONS, SEE DOOR SCHEDULE, A9.0  
6. ALL (E) INTERIOR FINISHES TO REMAIN UNLESS OTHERWISE NOTED  
7. TOUCH UP INTERIOR PAINT AT GYP BD ADJACENT TO WINDOWS  
8. FOR ALL FLASHING DIMENSIONS, USE SMACNA STANDARDS.  
9. INSTALL AN UNDERLAYMENT, EX-4, 24" AROUND ALL WINDOW PENETRATIONS PRIOR TO INSTALLMENT OF (N) WINDOW SYSTEMS.

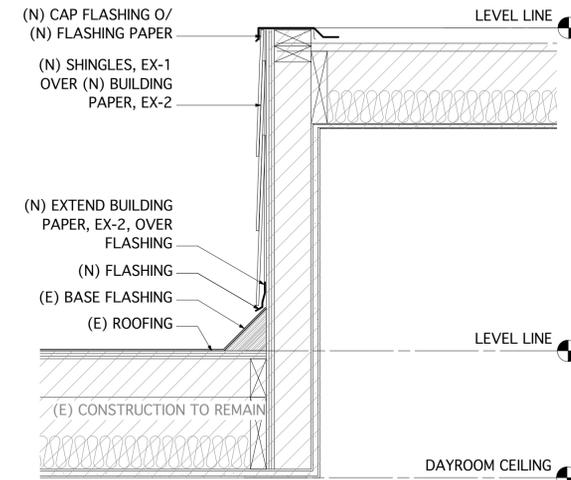

3 SECTION THROUGH CLERESTORY AT WALL  
Scale: 1 1/2" = 1'-0"

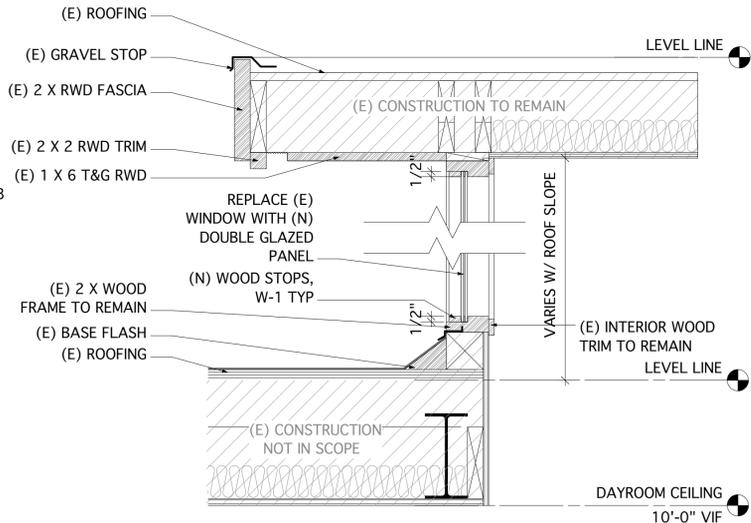

2 SECTION THROUGH CLERESTORY AT GLASS  
Scale: 1 1/2" = 1'-0"

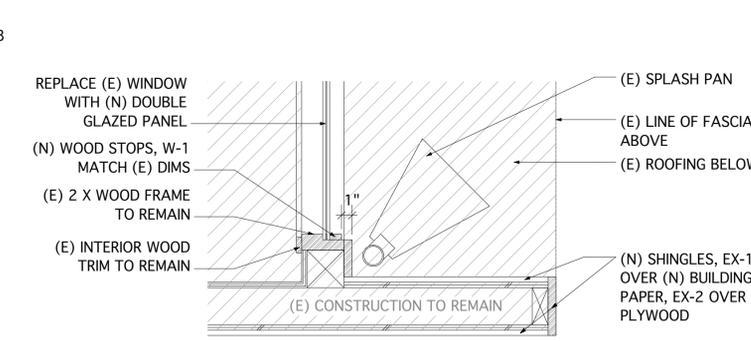

1 PLAN AT CLERESTORY CORNER / JAMB  
Scale: 1 1/2" = 1'-0"

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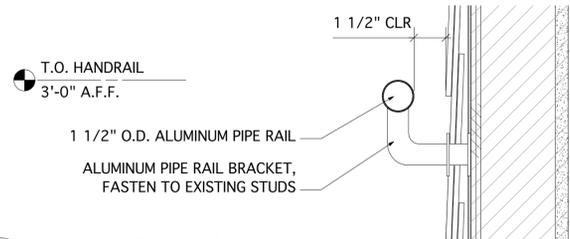
**KENSINGTON FIRE STATION**

215 ARLINGTON AVE.  
KENSINGTON, CA


|            |         |
|------------|---------|
| JOB NUMBER | 0906    |
| DATE       | 4/30/10 |
| DRAWN BY   | AT, MJ  |
| SCALE      |         |

**DOOR AND WINDOW DETAILS**


SHEET NUMBER  
**A7.3**




12 HANDRAIL AT BUILDING FACE  
Scale: 3" = 1'-0"

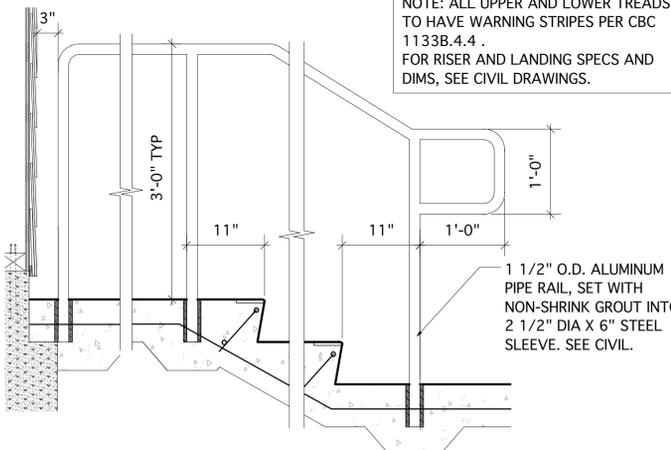

11 HANDRAIL, TYPICAL  
Scale: 1" = 1'-0"

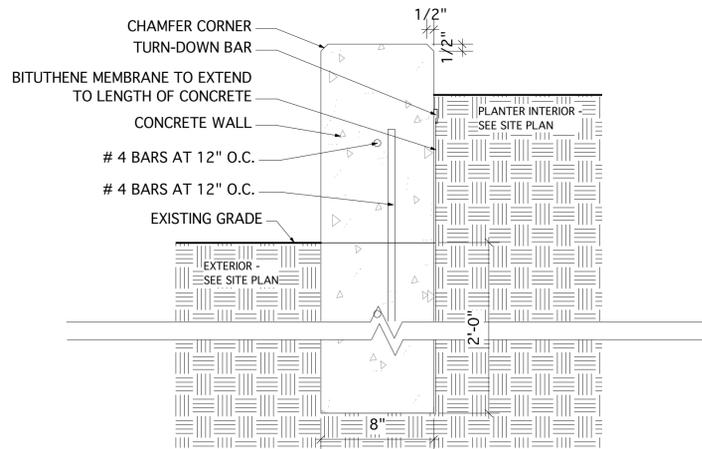


10 CONCRETE PLANTER WALL  
Scale: 2" = 1'-0"

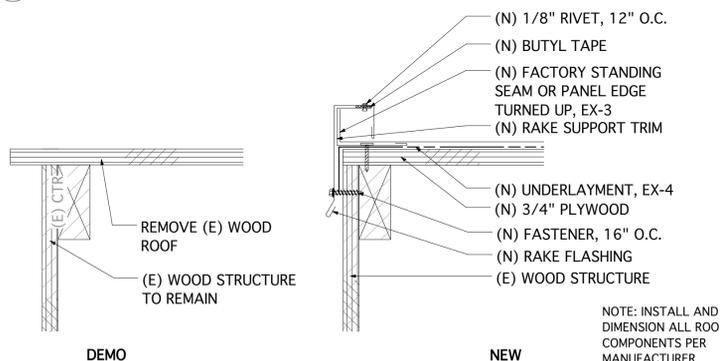


9 NEW ROOF AT OUTDOOR STORAGE LOCKERS - RAKE TRIM  
Scale: 3" = 1'-0"

NOTE: ALL UPPER AND LOWER TREADS TO HAVE WARNING STRIPES PER CBC 1133B.4.4. FOR RISER AND LANDING SPECS AND DIMS, SEE CIVIL DRAWINGS.


NOTE: INSTALL AND DIMENSION ALL ROOF COMPONENTS PER MANUFACTURER SPECIFICATIONS

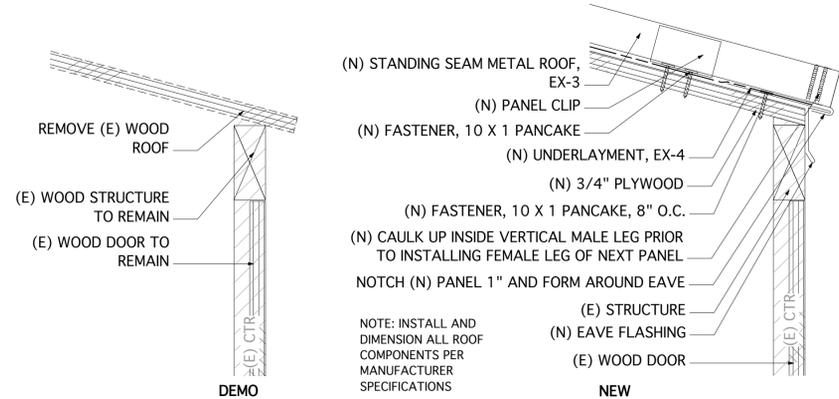


8 NEW ROOF AT OUTDOOR STORAGE LOCKERS - PEAK  
Scale: 3" = 1'-0"

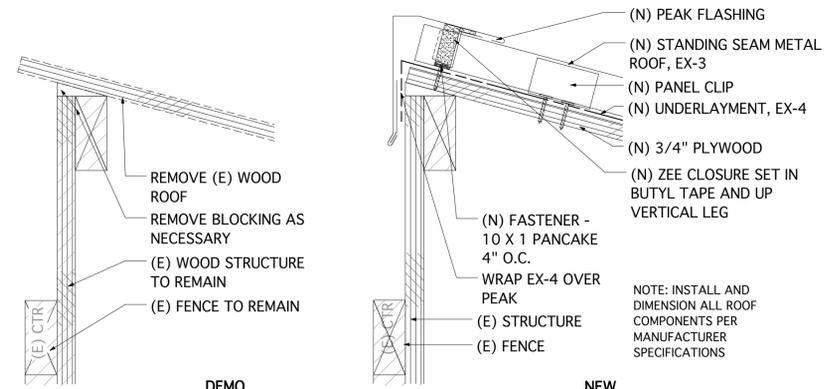

7 NEW ROOF AT OUTDOOR STORAGE LOCKERS - EAVE  
Scale: 3" = 1'-0"

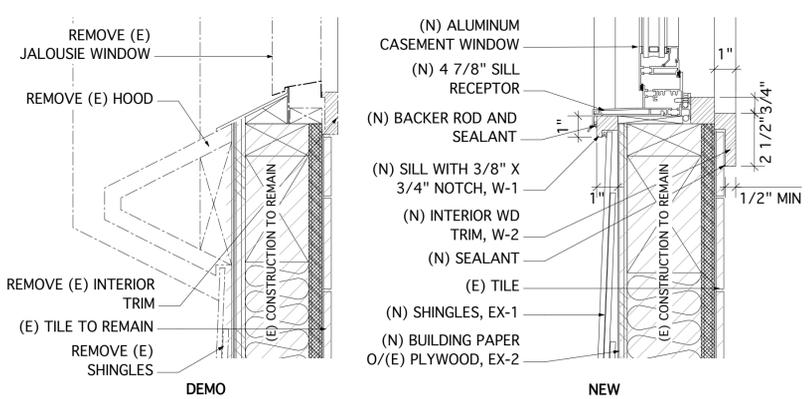


6 NEW ALUMINUM WINDOW AT (E) JALOUSIE / TYPE A - SILL AT TILE  
Scale: 3" = 1'-0"

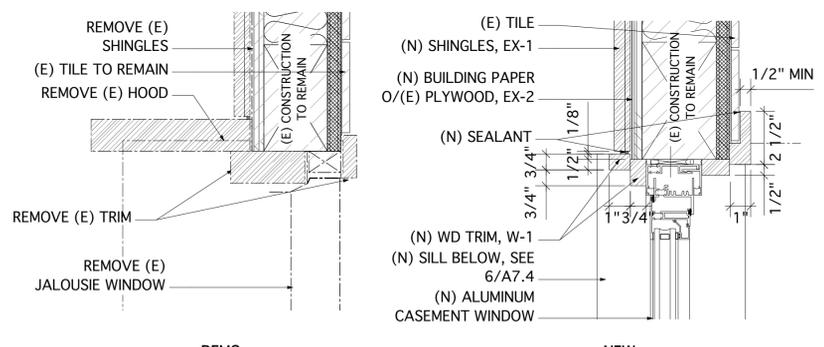


5 NEW ALUMINUM WINDOW AT (E) JALOUSIE / TYPE A - JAMB AT TILE  
Scale: 3" = 1'-0"


DETAIL NOTES  
1. VERIFY ALL DIMENSIONS IN FIELD. DETAILS ARE BASED FROM OWNER'S ARCHIVED DRAWINGS. ARCHIVED DRAWINGS ARE AVAILABLE FOR REVIEW AT JOBSITE.  
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4. ALL (E) INTERIOR FINISHES TO REMAIN UNLESS OTHERWISE NOTED  
5. TOUCH UP INTERIOR PAINT AT GYP BD ADJACENT TO WINDOWS  
6. FOR ALL FLASHING DIMENSIONS, USE SMACNA STANDARDS

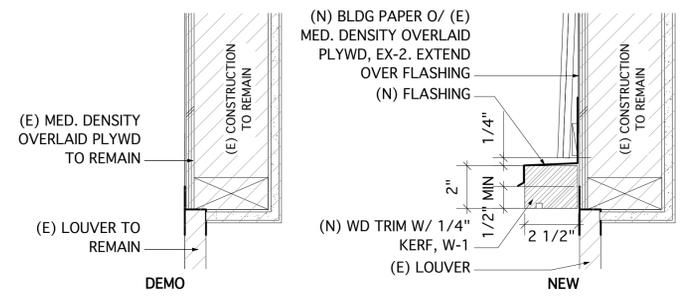


4 HEAD AT LOUVER  
Scale: 3" = 1'-0"

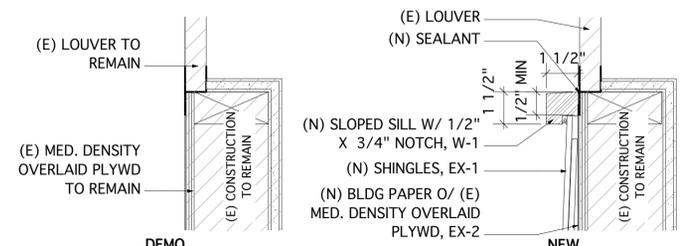

3 SILL AT LOUVER  
Scale: 3" = 1'-0"

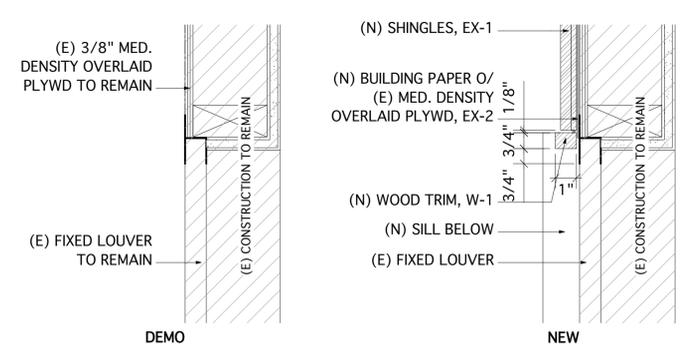

2 JAMB AT LOUVER  
Scale: 3" = 1'-0"

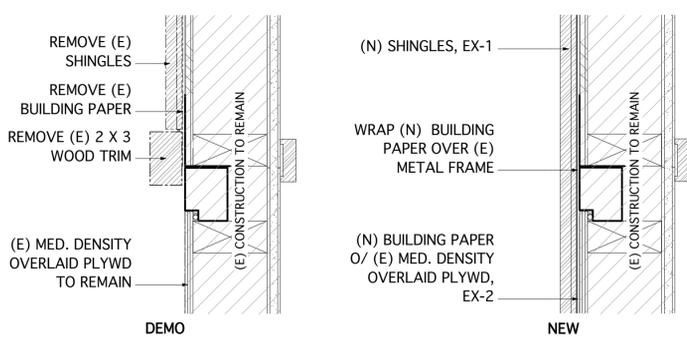

1 JAMB AT PANEL  
Scale: 3" = 1'-0"

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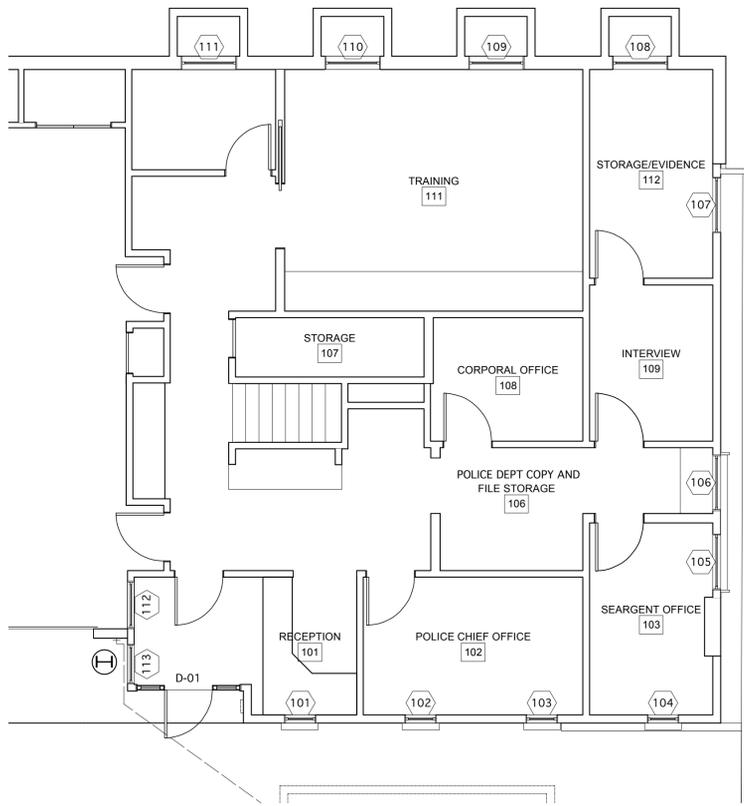
PROJECT  
**KENSINGTON FIRE STATION**

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KENSINGTON, CA


JOB NUMBER 0906  
DATE 4/30/10  
DRAWN BY AT, MJ  
SCALE

DESCRIPTION  
**DETAILS**

SHEET NUMBER  
**A7.4**



1 PARTIAL FIRST FLOOR PLAN  
Scale: 3/16" = 1'-0"

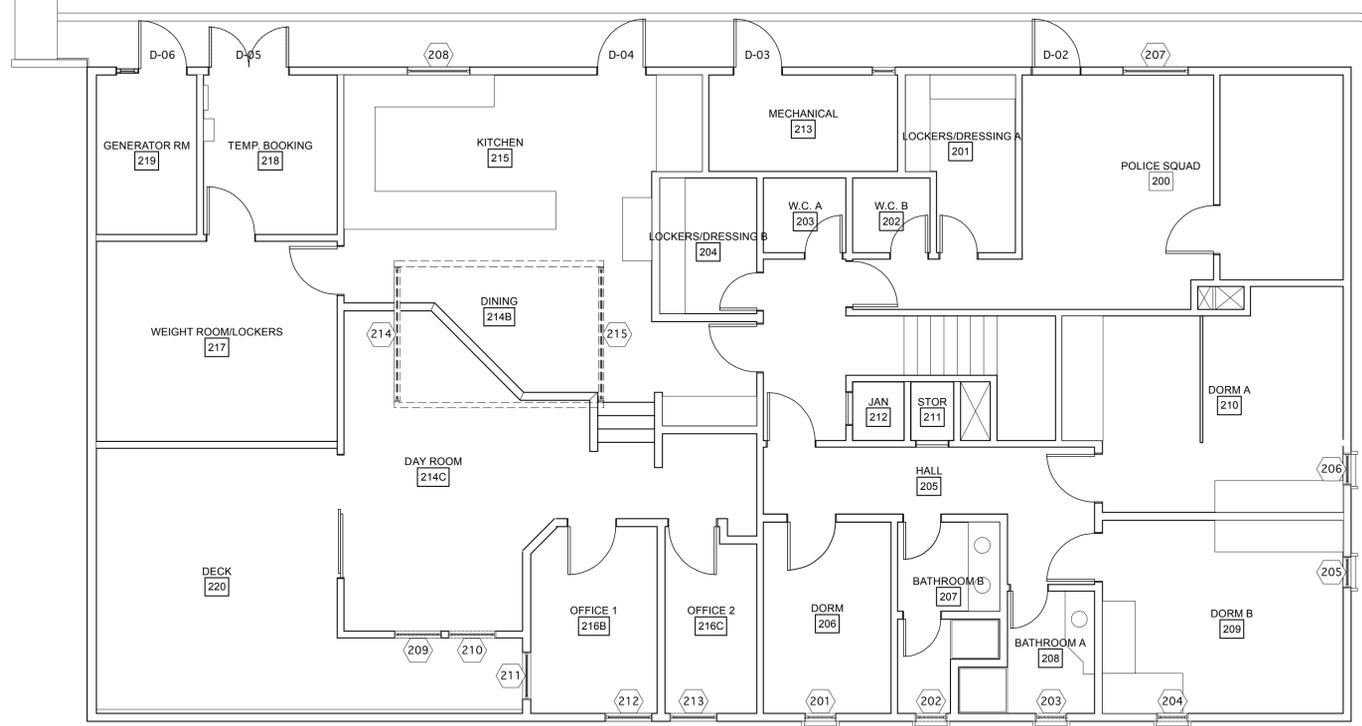


2 SECOND FLOOR PLAN  
Scale: 3/16" = 1'-0"

MATERIALS AND FINISHES SCHEDULE

|      |  |   |
|------|--|---|
| EX-1 | 16" HARDIPANEL SHINGLE - 7" EXPOSURE<br>INSTALL PER MANUFACTURER SPECS USING HARDIEPLANK<br>LAP SIDING STARTER COURSE OR EQUIVALENT<br>NOTE: FASTEN DIRECTLY TO (E) STUDS                      | W-1 SOLID REDWOOD (EXTERIOR TRIM)<br>W-2 FINGERJOINTED PINE (INTERIOR TRIM)                 |
| EX-2 | HARDIEWRAP WEATHERBARRIER  | P-1 PAINT SPEC AT SHINGLES, TBD   |
| EX-3 | STANDING SEAM METAL ROOF<br>CUSTOM-BILT METALS<br>MODEL CB100 - TITAN MECHANICAL SEAM<br>PREFINISHED ALUMINUM, .032 THICKNESS<br>TITAN COOL ROOF REFLECTIVE PAINT, COLOR TBD<br>1.800.826.7813 | P-2 PAINT SPEC AT EXTERIOR TRIM AND DOORS, TBD<br>P-3 PAINT SPEC AT INTERIOR GYP, MATCH (E) |
| EX-4 | HIGH TEMPERATURE SELF-ADHERING RUBBERIZED<br>MEMBRANE UNDERLAYMENT   |   |

WINDOW TYPES

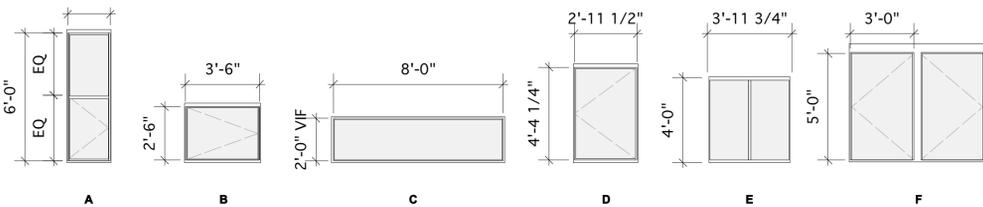


WINDOW NOTES

- FIELD VERIFY ALL WINDOW SIZES AGAINST ROUGH OPENINGS AND SUBMIT SHOP DRAWINGS TO ARCHITECT FOR APPROVAL BEFORE WINDOW ORDER PURCHASE.
- ALL DIMENSIONS ARE TO ROUGH OPENING.
- ALL OPERABLE WINDOWS SHALL BE PROVIDED WITH SCREENS, PREFERABLY ON THE INTERIOR.
- ALL GLAZING WITHIN 2'-0" OF FLOOR TO BE TEMPERED.
- ALL GLAZING IN BATHROOMS TO BE TEMPERED.
- FIT ALL OPERABLE WINDOWS, EXISTING AND NEW, WITH SCREENS.

DOOR NOTES

- FIELD VERIFY ALL DOOR SIZES AGAINST ROUGH OPENINGS AND SUBMIT SHOP DRAWINGS TO ARCHITECT FOR APPROVAL BEFORE WINDOW ORDER PURCHASE.

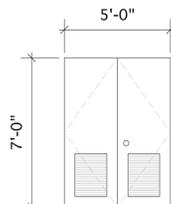

Window Schedule

| Mark | Window Style |                |           | Glass                 | Window Data                     | Details       |         |        |        | Comments                                 |
|------|--------------|----------------|-----------|-----------------------|---------------------------------|---------------|---------|--------|--------|--|
|      | Type         | Sash Operation | Top Shape |                       |                                 | Specification | Head    | Sill   | Jamb   |  |
| 101  | A            | SINGLE HUNG    | SQUARE    | CG C-C60 - DBL GLAZED | KAWNEER 6200T Outswing Casement | 3/A7.1        | 2/A7.1  | 1/A7.1 | N/A    | -  |
| 102  | A            | SINGLE HUNG    | SQUARE    | CG C-C60 - DBL GLAZED | KAWNEER 6200T Outswing Casement | 3/A7.1        | 2/A7.1  | 1/A7.1 | N/A    | -  |
| 103  | A            | SINGLE HUNG    | SQUARE    | CG C-C60 - DBL GLAZED | KAWNEER 6200T Outswing Casement | 3/A7.1        | 2/A7.1  | 1/A7.1 | N/A    | -  |
| 104  | A            | (E)            | (E)       | (E)                   | (E)                             | 6/A7.1        | 5/A7.1  | 4/A7.1 | N/A    | -  |
| 105  | B            | SINGLE HUNG    | SQUARE    | CG C-C60 - DBL GLAZED | KAWNEER 6200T Outswing Casement | 3/A7.2        | 2/A7.2  | 1/A7.2 | 4/A7.2 | -  |
| 106  | B            | SINGLE HUNG    | SQUARE    | CG C-C60 - DBL GLAZED | KAWNEER 6200T Outswing Casement | 3/A7.2        | 2/A7.2  | 1/A7.2 | 4/A7.2 | -  |
| 107  | -            | (E)            | (E)       | (E)                   | (E)                             | -             | -       | -      | N/A    | Replace trim at louver                   |
| 108  | -            | (E)            | (E)       | (E)                   | (E)                             | (E)           | (E)     | (E)    | N/A    | -  |
| 109  | -            | (E)            | (E)       | (E)                   | (E)                             | (E)           | (E)     | (E)    | N/A    | -  |
| 110  | -            | (E)            | (E)       | (E)                   | (E)                             | (E)           | (E)     | (E)    | N/A    | -  |
| 111  | -            | (E)            | (E)       | (E)                   | (E)                             | (E)           | (E)     | (E)    | N/A    | -  |
| 112  | -            | (E)            | (E)       | (E)                   | (E)                             | (E)           | (E)     | (E)    | N/A    | -  |
| 113  | -            | (E)            | (E)       | (E)                   | (E)                             | (E)           | (E)     | (E)    | N/A    | -  |
| 201  | SIM. A       | SINGLE HUNG    | SQUARE    | CG C-C60 - DBL GLAZED | KAWNEER 6200T Outswing Casement | 3/A7.1        | 2/A7.1  | 1/A7.1 | N/A    | Reframe (E) 22"x72" to meet egress codes |
| 202  | A            | SINGLE HUNG    | SQUARE    | CG C-C60 - DBL GLAZED | KAWNEER 6200T Outswing Casement | 3/A7.1        | 6/A7.4  | 5/A7.4 | N/A    | -  |
| 203  | A            | SINGLE HUNG    | SQUARE    | CG C-C60 - DBL GLAZED | KAWNEER 6200T Outswing Casement | 3/A7.1        | 6/A7.4  | 5/A7.4 | N/A    | -  |
| 204  | A            | SINGLE HUNG    | SQUARE    | CG C-C60 - DBL GLAZED | KAWNEER 6200T Outswing Casement | 3/A7.1        | 2/A7.1  | 1/A7.1 | N/A    | -  |
| 205  | A            | (E)            | (E)       | (E)                   | (E)                             | 6/A7.1        | 5/A7.1  | 4/A7.1 | N/A    | Verify existing aluminum windows         |
| 206  | A            | (E)            | (E)       | (E)                   | (E)                             | 6/A7.1        | 5/A7.1  | 4/A7.1 | N/A    | Verify existing aluminum windows         |
| 207  | E            | (E)            | (E)       | (E)                   | (E)                             | 10/A7.2       | 9/A7.2  | 8/A7.2 | N/A    | -  |
| 208  | E            | (E)            | (E)       | (E)                   | (E)                             | 10/A7.2       | 9/A7.2  | 8/A7.2 | N/A    | -  |
| 209  | F            | FIXED          | SQUARE    | CG C-C60 - DBL GLAZED | TBD                             | 11/A7.3       | 10/A7.3 | 9/A7.3 | 8/A7.3 | -  |
| 210  | F            | FIXED          | SQUARE    | CG C-C60 - DBL GLAZED | TBD                             | 11/A7.3       | 10/A7.3 | 9/A7.3 | 8/A7.3 | -  |
| 211  | D            | (E)            | (E)       | (E)                   | (E)                             | 7/A7.2        | 6/A7.2  | 5/A7.2 | N/A    | -  |
| 212  | D            | (E)            | (E)       | (E)                   | (E)                             | 7/A7.2        | 6/A7.2  | 5/A7.2 | N/A    | -  |
| 213  | D            | (E)            | (E)       | (E)                   | (E)                             | 7/A7.2        | 6/A7.2  | 5/A7.2 | N/A    | -  |
| 214  | C            | FIXED          | SQUARE    | CG C-C60 - DBL GLAZED | TBD                             | 2/A7.3        | 2/A7.3  | 1/A7.3 | N/A    | -  |
| 215  | C            | FIXED          | SQUARE    | CG C-C60 - DBL GLAZED | TBD                             | 2/A7.3        | 2/A7.3  | 1/A7.3 | N/A    | -  |

Door Schedule

| Mark | Nominal Size |        |         | Door Style      |           |            | Hardware |           |      | Details |           |        | Comments              |
|------|--------------|--------|---------|-----------------|-----------|------------|----------|-----------|------|---------|-----------|--------|-----------------------|
|      | Width        | Height | Dr Thck | Door Operation  | Top Shape | Slab Style | Lvr Mfr  | Lvr Model | Lock | Head    | Threshold | Jamb   |                       |
| D-01 | (E)          | (E)    | (E)     | (E)             | (E)       | (E)        | (E)      | (E)       | (E)  | (E)     | (E)       | (E)    |                       |
| D-02 | (E)          | (E)    | (E)     | (E)             | (E)       | (E)        | (E)      | (E)       | (E)  | (E)     | (E)       | (E)    |                       |
| D-03 | (E)          | (E)    | (E)     | (E)             | (E)       | (E)        | (E)      | (E)       | (E)  | (E)     | (E)       | (E)    |                       |
| D-04 | (E)          | (E)    | (E)     | (E)             | (E)       | (E)        | (E)      | (E)       | (E)  | (E)     | (E)       | (E)    |                       |
| D-05 | 5'-0"        | 7'-0"  | 1 3/4"  | SIMPLE BI-SWING | Square    | MATCH (E)  | TBD      | TBD       | TBD  | 6/A7.3  | 5/A7.3    | 4/A7.3 | MATCH (E) METAL DOORS |
| D-06 | (E)          | (E)    | (E)     | (E)             | (E)       | (E)        | (E)      | (E)       | (E)  | (E)     | (E)       | (E)    |                       |

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| DATE     | DESCRIPTION      |
|----------|------------------|
| 04.30.10 | BID / PERMIT SET |
|          |                  |
|          |                  |
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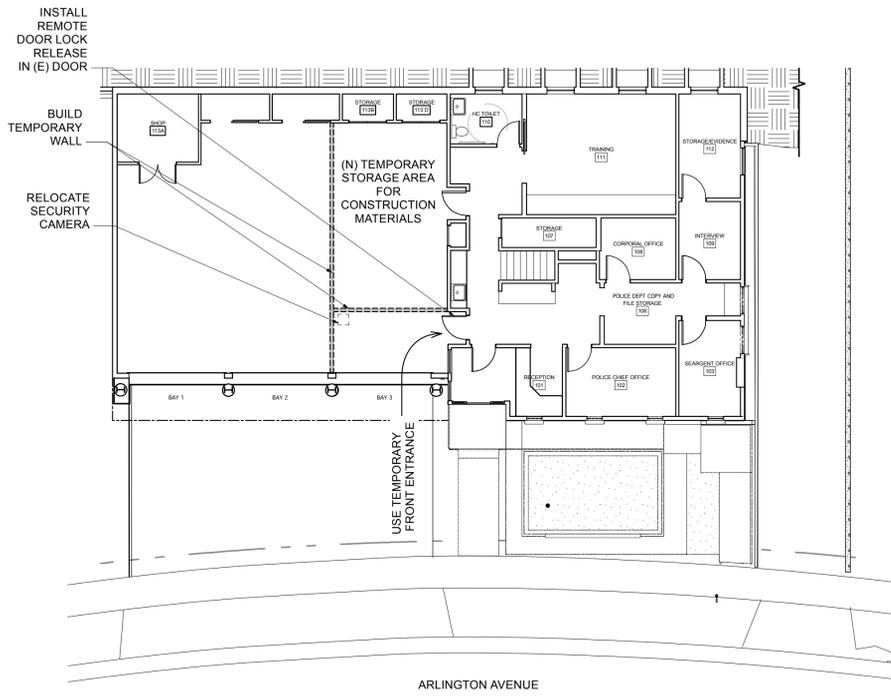
PROJECT  
**KENSINGTON FIRE STATION**

215 ARLINGTON AVE.  
KENSINGTON, CA


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| JOB NUMBER  | 0906    |
| DATE        | 4/30/10 |
| DRAWN BY    | AT, MJ  |
| SCALE       |         |
| DESCRIPTION |         |

**SCHEDULE**


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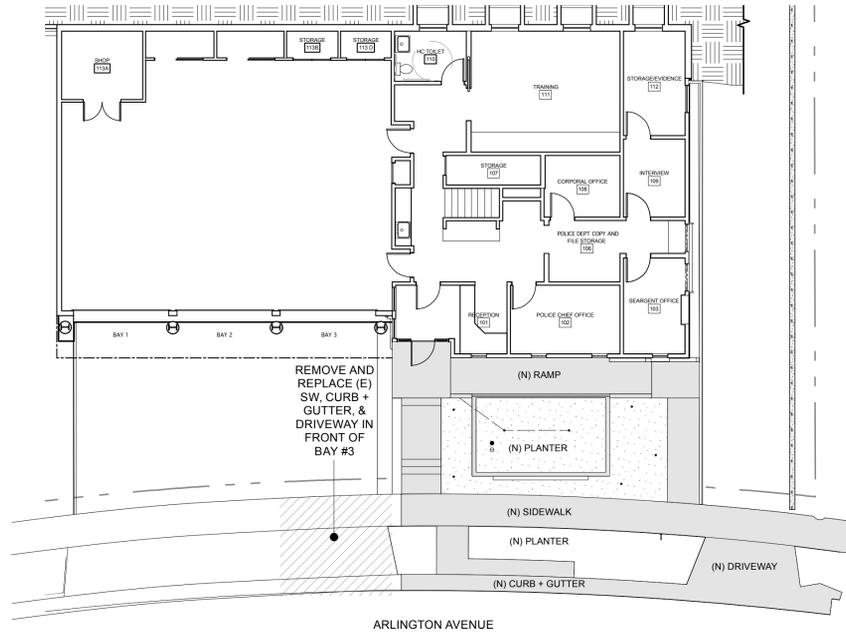
CONSTRUCTION PHASE 1




CONSTRUCTION PHASE 2

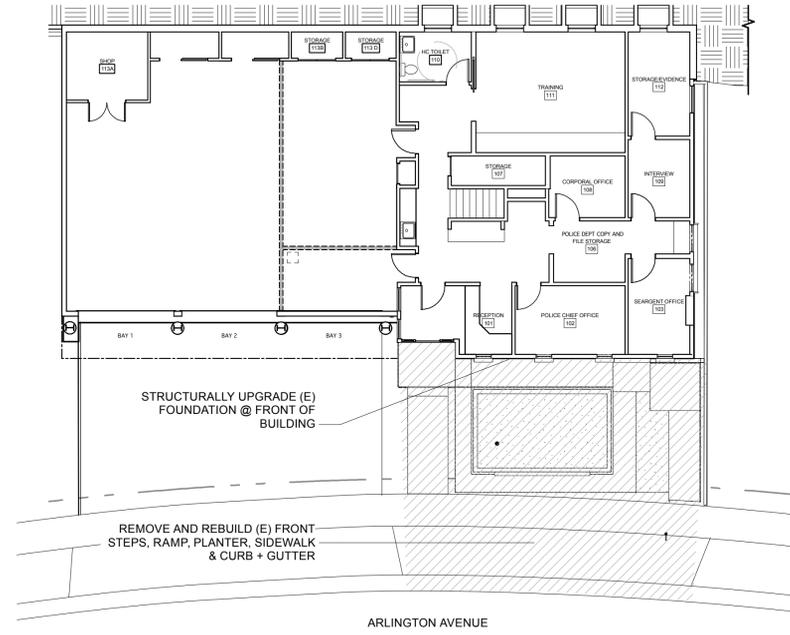


CONSTRUCTION PHASE 3

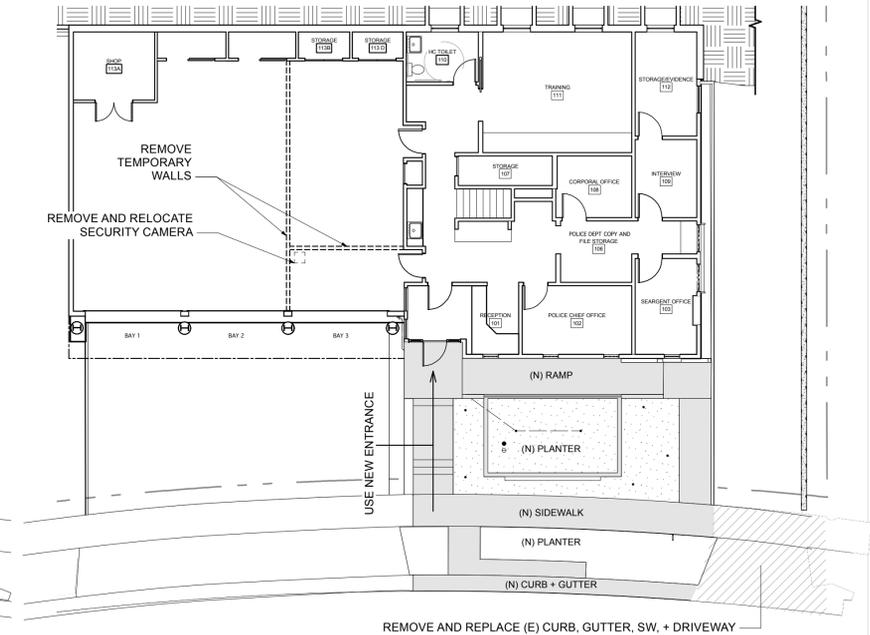

CONSTRUCTION PHASE 4

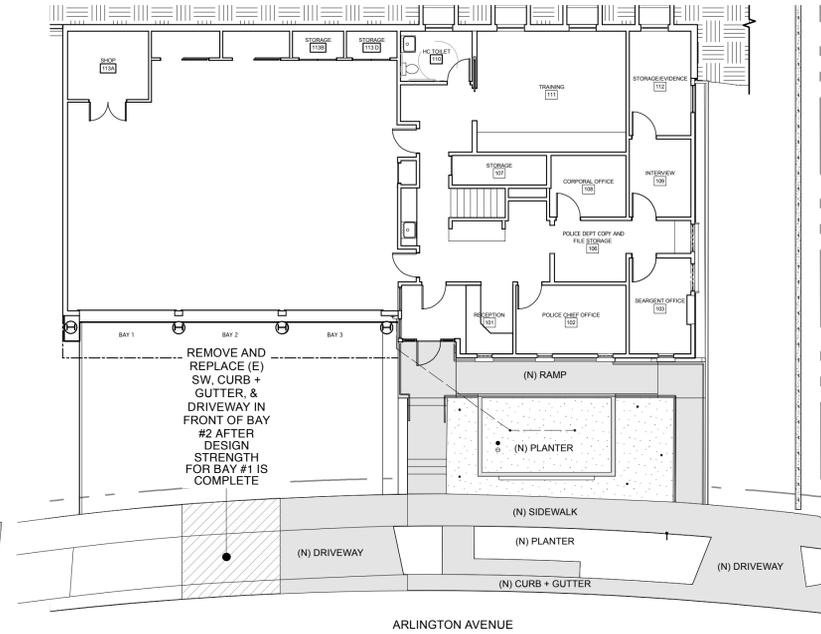

CONSTRUCTION PHASE 5

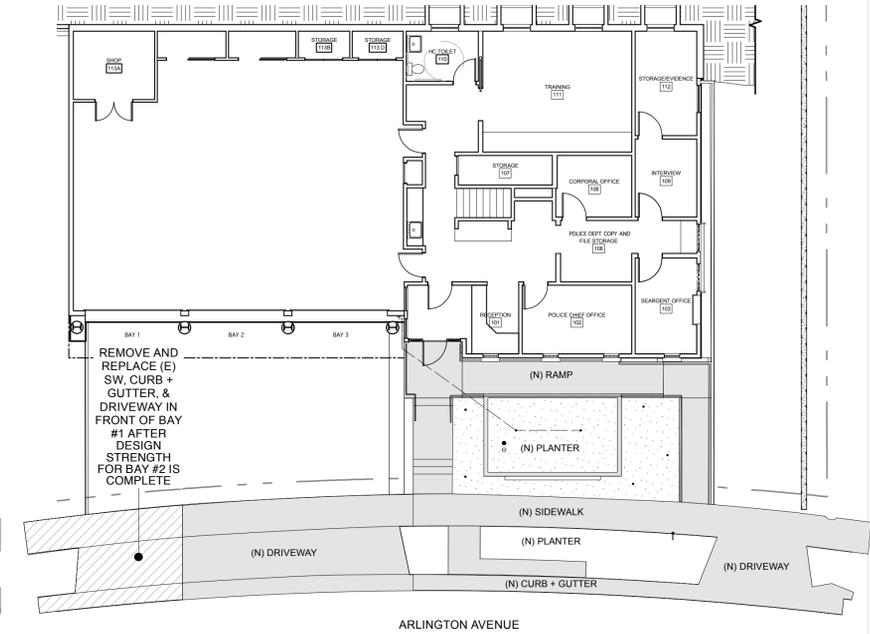

CONSTRUCTION PHASE 6

**CONSTRUCTION PHASING DIAGRAM NOTES**

1. THE PHASING DIAGRAM ABOVE ILLUSTRATES ONE POSSIBLE MEANS OF CONSTRUCTION WORKFLOW TO PRESERVE THE FUNCTIONALITY OF AT LEAST 2 OF THE 3 BAYS AT THE DRIVEWAY APRON AT ALL TIMES. THIS DIAGRAM IN NO WAY SUPERSEDES ANY PROPOSED BEST PRACTICES WHICH DELIVER THE SAME DRIVEWAY FUNCTIONALITY.

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| DATE     | DESCRIPTION      |
|----------|------------------|
| 04.30.10 | BID / PERMIT SET |
|          |                  |
|          |                  |
|          |                  |

**KENSINGTON FIRE STATION**

215 ARLINGTON AVE.  
KENSINGTON, CA

|             |         |
|-------------|---------|
| JOB NUMBER  | 0906    |
| DATE        | 4/30/10 |
| DRAWN BY    | AT, MJ  |
| SCALE       |         |
| DESCRIPTION |         |

**CONSTRUCTION PHASING DIAGRAM**

SHEET NUMBER

A10.0